


# Wastewater Side Sewer Improvements Wastewater Sid McKinley Road

**Environmental Services Department** June 2024

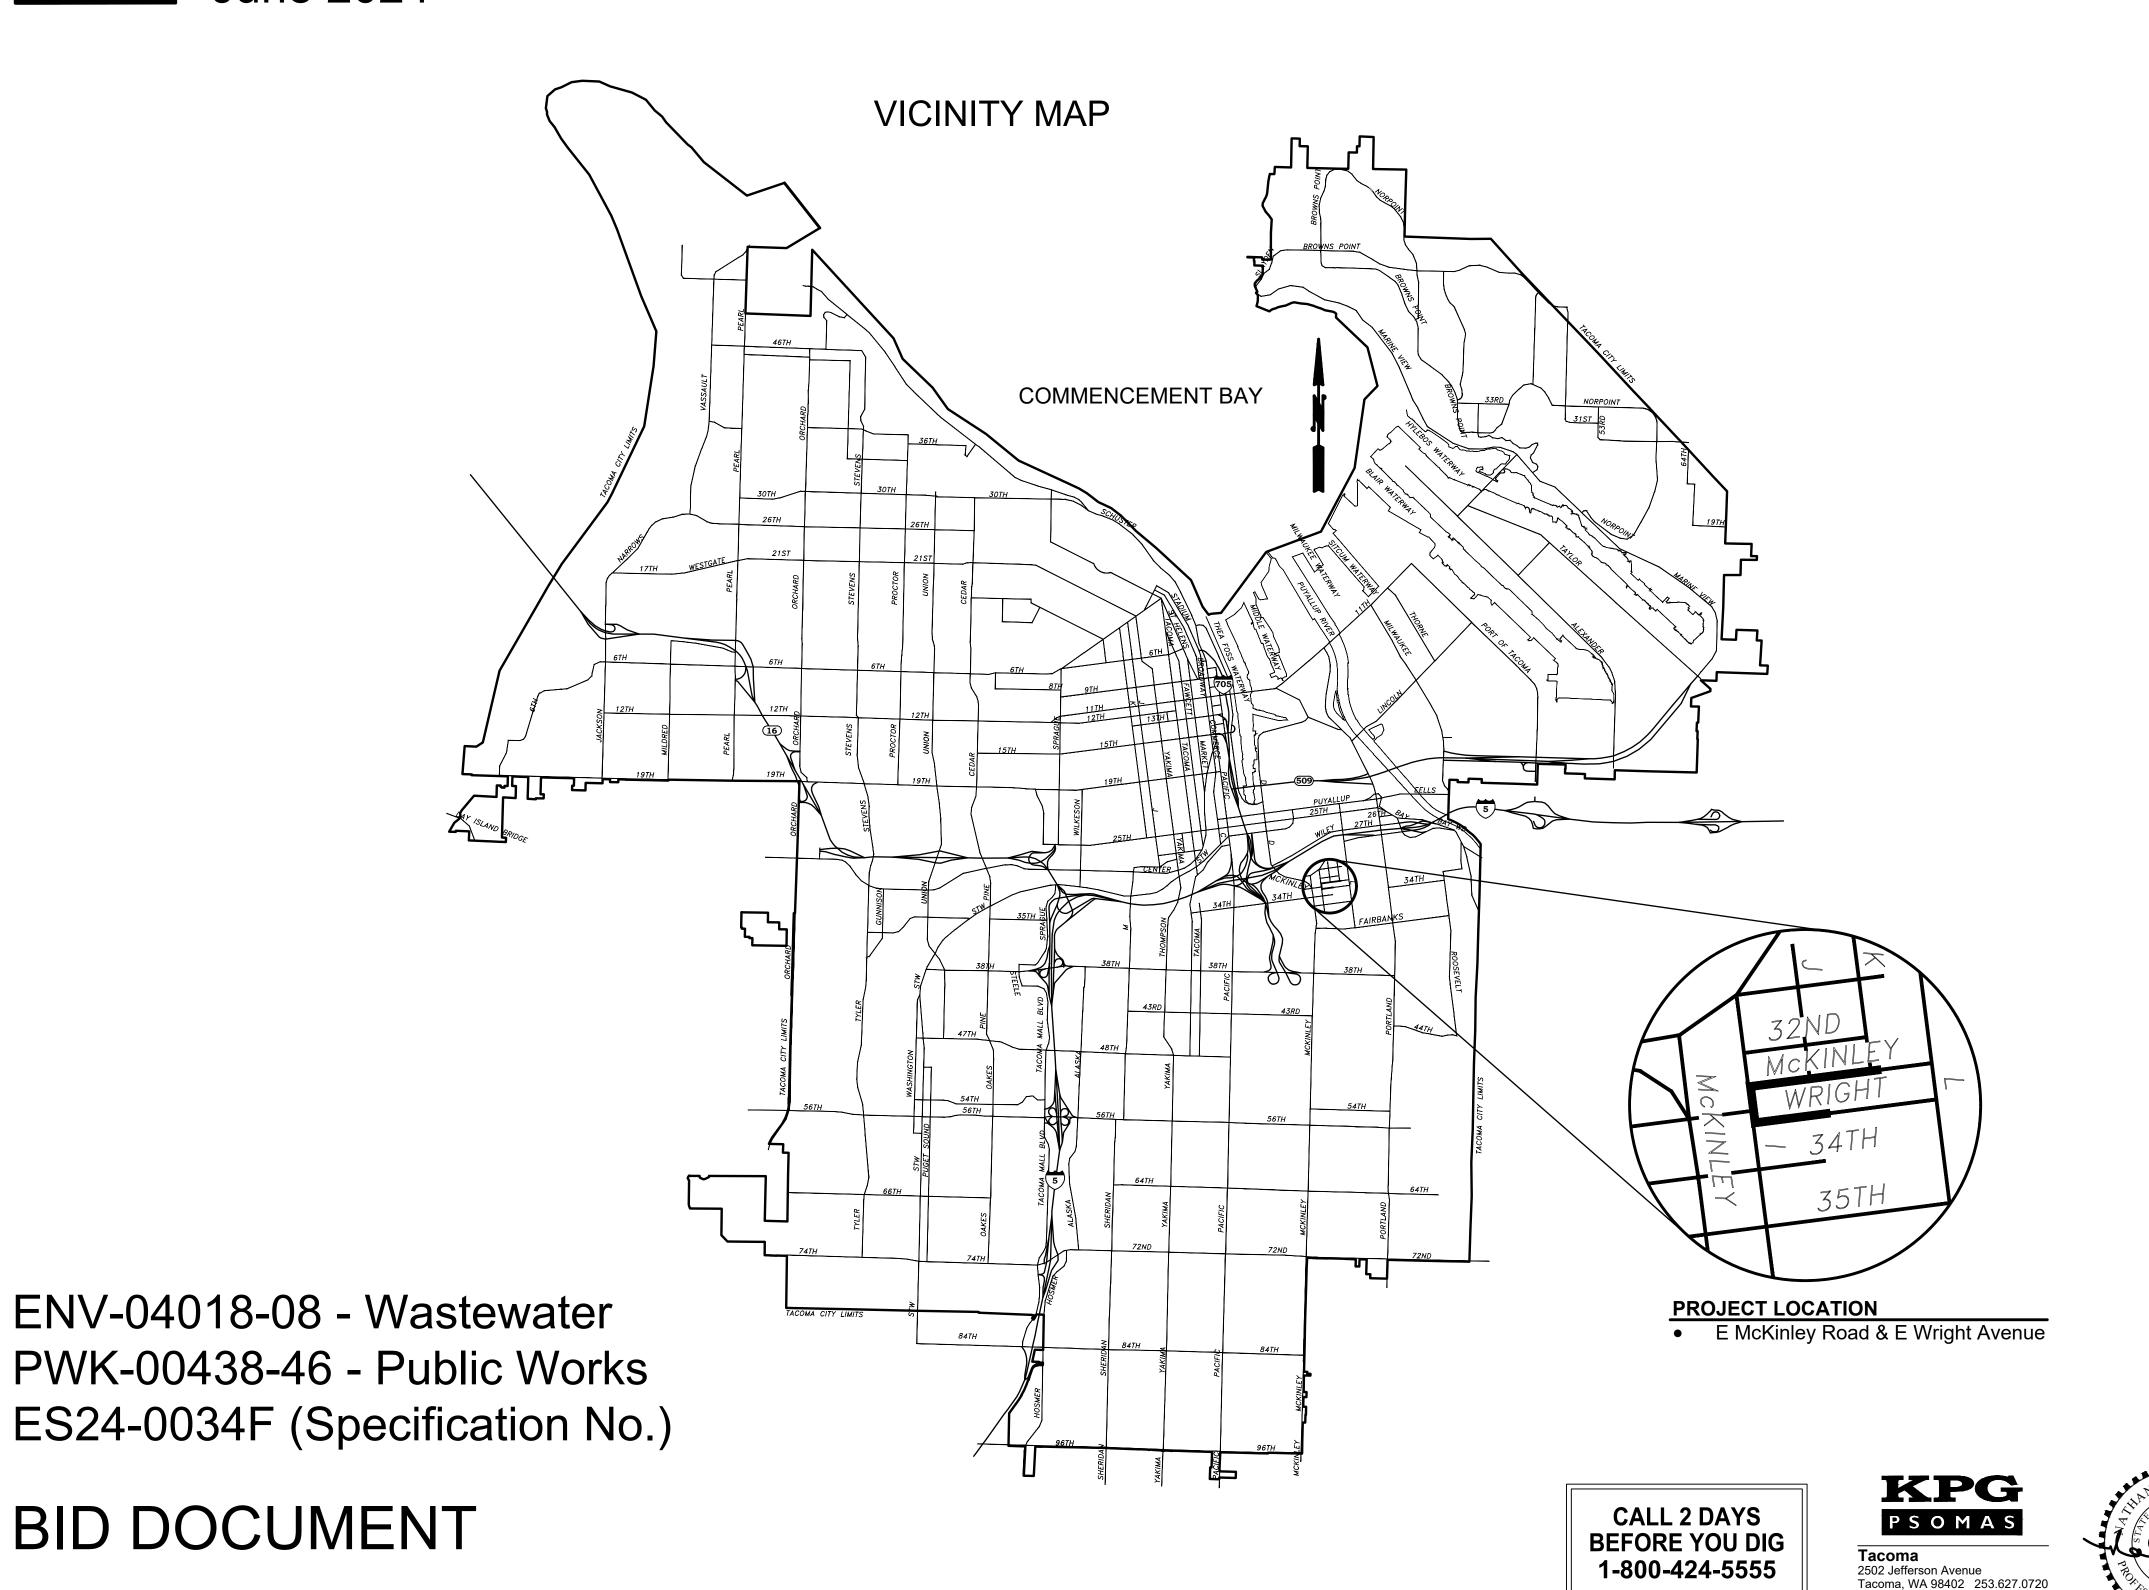


INDEX OF DRAWINGS SHEET TITLE OF DRAWINGS NUMBER Cover Sheet Legend & Abbreviations Alignment & Survey Control Data Demolition Plan & TESC - McKinley Road Demolition Plan & TESC - McKinley Road Demolition Plan & TESC - E Wright Avenue Side Sewer Plan & Profile - 3251 - East I Street Private Improvement Restoration Plan - 3251 - East I Street Side Sewer Plan & Profile - 906 McKinley Road Private Improvement Restoration Plan - 906 McKinley Road Side Sewer Plan & Profile - 920 McKinley Road 11 Private Improvement Restoration Plan - 920 McKinley Road Side Sewer Plan & Profile - 924 McKinley Road Private Improvement Restoration Plan - 924 McKinley Road Side Sewer Plan & Profile - 930 McKinley Road Private Improvement Restoration Plan - 930 McKinley Road Side Sewer Plan & Profile - 934 McKinley Road 17 Private Improvement Restoration Plan - 934 McKinley Road Side Sewer Plan & Profile - 938 McKinley Road Private Improvement Restoration Plan - 938 McKinley Road Side Sewer Plan & Profile - 944 McKinley Road Private Improvement Restoration Plan - 944 McKinley Road Side Sewer Plan & Profile - 948 McKinley Road 23 Private Improvement Restoration Plan - 948 McKinley Road Side Sewer Plan & Profile - 952 McKinley Road Private Improvement Restoration Plan - 952 McKinley Road Side Sewer Plan & Profile - 905 E Wright Avenue Private Improvement Restoration Plan - 905 E Wright Avenue McKinley Road Plan & Profile, ROW & Restoration Plan McKinley Road Plan & Profile, ROW & Restoration Plan E Wright Avenue Road Plan & Profile, ROW & Restoration Plan Curb Ramp & Intersection Grading Plan -32 - 33 McKinley Road & East J Street Curb Ramp & Intersection Grading Plan -McKinley Road & East K Street **Typical Sections** Typical Details


	REFERENCE LINETYPES		WATER	POWER	TRAFFIC SI	GNAL INTERCONNECT AND LIGHTING	ABBREVIATIONS	GENERAL SEWER NOTES
EXISTI	NG .	DESCRIPTION	SYMBOL DESCRIPTION	SYMBOL DESCRIPTION	SYMBOL	DESCRIPTION	& AND MAX MAXIMUM	UTILITIES SHOWN ON THE PLAN AND PROFILE VIEW ARE
		PROPERTY LINE	EXIST PROP  SPRINKLER HEAD	EXIST PROP  POWER POLE	EXIST PR	OP	@ AT MB MAILBOX - , CL CENTERLINE MED MEDIUM , PL PROPERTY LINE MEMB MEMBRANE	APPROXIMATE LOCATIONS FROM BEST AVAILABLE INFORMATION AND MAY BE INCOMPLETE. UTILITY CROSSINGS ARE ONLY SHOWN ON THE PROFILE VIEW IF
	l	EASEMENT LINE	SPRINKLER CONTROL BC			DIAMOND DETECTOR 6X8	% PERCENT MET METAL #, NO NUMBER MFR MANUFACTURER	POTHOLE OR RECORD DRAWING ELEVATIONS ARE AVAILABLE. THE CONTRACTOR SHALL BE RESPONSIBLE
ROW		RIGHT OF WAY	-Ò- FIRE HYDRANT  M GATE VALVE	(UNDERGROUND)		SQUARE DETECTOR 6X6	Ø, DIA DIAMETER MH MANHOLE  MIN MINIMUM  AC ACRE MISC MISCELLANEOUS	FOR LOCATING AND PROTECTING ALL EXISTING UTILITIES. CALL TWO BUSINESS DAYS BEFORE YOU DIG
		CENTER LINE	⊕ CROSS	POWER VAULT (ABOVE GROUND)		CIRCLE DETECTOR 6'	AGGR AGGREGATE MON MONUMENT ALT ALTERNATE AP ANGLE POINT N NORTH	(1-800-424-5555) OR VISIT ONLINE WWW.CALLBEFOREYOUDIG.ORG.
		TEMPORARY CONSTRUCTION PERMIT LINE	P TEE  A REDUCER	← POLE ANCHOR		VIDEO CAMERA	APPROX APPROXIMATELY NTS NOT TO SCALE ASPH ASPHALT	2. ALL SIDE SEWERS SHALL BE 6" DIAMETER UNLESS OTHERWISE STATED IN THE PLANS. THE SIDE SEWER PIPE
	'	PERMIT LINE	⊞ WATER METER		<del>3</del> D-	EV INDICATOR LIGHTS	OC ON CENTER B&B BALLED AND BURLAPPED OD OUTSIDE DIAMETER OPP OPPOSITE	MATERIAL SHALL BE IN ACCORDANCE WITH CITY OF TACOMA SPECIAL PROVISION 7-18. IF A SIDE SEWER IS LOCATED WITHIN 10' OF A WATER SERVICE, THE
	FEATURE LINETYPES	D.F.G.CD.IDELOV	SEWER	COMMUNICATION	<i>ŏ</i> ₁	PED. PUSHBUTTON (1)	C&G CLEARING & GRUBBING CB CATCH BASIN PA PLANTING AREA	CONTRACTOR SHALL USE SOLID WALL PVC PRESSURE PIPE PER SECTION 7-18.3(1) OF THE CITY OF TACOMA
EXISTING	PROPOSED	DESCRIPTION	SYMBOL DESCRIPTION  EXIST PROP	SYMBOL DESCRIPTION  EXIST PROP	-   -	TENON	CEM CEMENT PAT PATTERN CF CUBIC FEET PC POINT OF CURVATURE CJ CONTROL JOINT PG PERFORMANCE GRADED	SPECIAL PROVISIONS.  3. THE STATIONING PROVIDED IN THE SIDE SEWER TABLE IS
	=	CURB & GUTTER	MANHOLE	TELECOMMUNICATIONS		PEDESTRIAN SIGNAL HEAD	CL CLASS POB POINT OF BEGINNING CLR CLEAR POC POINT OF CONNECTION	ESTIMATED BASED ON THE VIDEO INSPECTION OF THE MAIN. THE LOCATION OF THE SIDE SEWER IS UNKNOWN PAST THE
		- EDGE OF CONCRETE		PEDESTAL	O	TRAFFIC SIGNAL POLE	CMP CORRUGATED PPB PEDESTRIAN PUSHBUTTON METAL PIPE PROP PROPOSED CMU CONCRETE PS PEDESTRIAN SIGNAL	CONNECTION AT THE EXISTING MAIN.  4. PRESERVE AND PROTECT ALL IMPROVEMENTS &
		- EDGE OF PAVEMENT	© CLEAN OUT	TELECOMMUNICATIONS VAULT	<b>→</b>	VEHICLE SIGNAL HEAD	MASONRY UNIT PT POINT OF TANGENCY CONC CONCRETE PVC POINT OF VERTICAL CURVE, CONST CONSTRUCT POLYVINYL CHLORIDE PIPE	STRUCTURES. REMOVE/TRIM VEGETATION ONLY TO EXTENTS NECESSARY TO CONSTRUCT IMPROVEMENTS.
		PERVIOUS PAVEMENT	© LAMP HOLE	TELECOMMUNICATIONS MANHOLE	<b>→</b>	VEHICLE SIGNAL HEAD W/ARROW INDICATOR	CONT CONTINUOUS PVI POINT OF VERTICAL INTERSECTION	<ol> <li>OVERHEAD POWER &amp; UTILITIES PRESENT THROUGHOUT PROJECT SITE.</li> </ol>
		EDGE OF GRAVEL / DIRT	STORM CATCH BASIN		<u> </u>	OVERHEAD SIGN ASSEMBLY	CSTC CRUSHED SURFACING TOP PVT POINT OF VERTICAL COURSE TANGENCY CSBC CRUSHED SURFACING	6. CONSTRUCTION ACTIVITIES SHALL BE PHASED AS
_		GUARD RAIL	CURB INLET		<u> </u>	TRAFFIC CONTROL SIGN	BASE COURSE R RADIUS CY CUBIC YARDS RCA RECYCLED CONC AGGREGATE	NECESSARY TO MAINTAIN ACCESS FOR RESIDENTS.  DRIVEWAY SHALL BE COORDINATED WITH THE ENGINEER
XX	XX	CHAINLINK FENCE	· AREA DRAIN		<b>→</b> -	■ SIGN	REINF REINFORCED DIP, DI DUCTILE IRON PIPE REM REMOVE DWG DRAWING REPL REPLACE	AND PROPERTY OWNER(S) A MINIMUM OF 24 HOURS IN ADVANCE.
						SIGNAL CONTROLLER CABINET	DWY DRIVEWAY REQD REQUIRED RIM RIM ELEVATION	7. CONTRACTOR SHALL PROVIDE TESC MEASURES IN ADDITION TO THOSE SHOWN IF REQUIRED TO PREVENT SEDIMENT
=======================================		TRAIL	> STORM CULVERT		⊠	JUNCTION BOX	E EAST ROW, R/W RIGHT OF WAY EA EACH RT RIGHT EJ EXPANSION JOINT S SOUTH	FROM LEAVING THE PROJECT SITE. CITY SHALL REVIEW AND APPROVE ALL TESC MEASURES PRIOR TO INSTALLATION.
		VEGETATION LINE	RIP RAP		N	JUNCTION BOX (LARGE)	ELEV ELEVATION SAN SANITARY SEWER EQ EQUAL SF SQUARE FEET	<ol> <li>PAVEMENT REMOVAL LIMITS MAY BE ADJUSTED IN THE FIELD TO ACCOMMODATE CONSTRUCTION METHODS. REMOVAL</li> </ol>
		RAILROAD BUILDINGS	PLUG		-0-	UTILITY POLE	EX, EXIST EXISTING SPECS SPECIFICATIONS SQ SQUARE	LIMITS SHALL BE MARKED IN THE FIELD BY THE CONTRACTOR AND CITY CONSTRUCTION INSPECTOR PRIOR TO COMMENCING DEMOLITION ACTIVITIES.
		WATER EDGE	SURVEY	ITEM/ REFERENCE DESIGNATION	ф—×	UTILITY POLE W/LIGHT	FFE FINISH FLOOR STA STATION ELEVATION STL STEEL FG FINISHED GRADE STM STORM SEWER	COMMENCING DEMOLITION ACTIVITIES.
		DRAINAGE DITCH	SYMBOL DESCRIPTION	SYMBOL DESCRIPTION	×	STREET LIGHT ON FOUNDATION	FIN FINISH TELEPHONE,	
		CONC RETAINING WALL	$\nabla$	CONSTRUCTION, SITE PREPARATION	×	ORNAMENTAL POST TOP	FT FOOT OR FEET TELECOMMUNICATIONS FTG FOOTING TEMP TEMPORARY TJ TOOLED JOINT	
.00000000000000000000000000000000000000		ROCK RETAINING WALL	SECTION CORNER	# CONSTRUCTION, SITE PREPARATION OR ROADWAY NOTE		MISCELLANEOUS	GA GAUGE TS TRAFFIC SIGNAL CONDUIT, GAL GALLON TOP OF SLOPE	
		SILT FENCE	QUARTER CORNER N/S	# SIDE SEWER NOTE	SYMBOL	MISCELLANEOUS  DESCRIPTION	GALV GALVANIZED TSFO TRAFFIC SIGNAL CONDUIT GRD BRK GRADE BREAK FIBEROPTIC TV CABLE TELEVISION	
	C&G	CLEARING AND GRUBBING	QUARTER CORNER E/W	# PRIVATE IMPROVEMENT NOTE	EXIST PR	OP	HDPE HIGH-DENSITY TW TOP OF WALL POLYETHYLENE TYP TYPICAL	
		SAWCUT/ MEET LINE	△ SPOT ELEVATION		P	MAIL BOX	HORIZ HORIZONTAL HP HIGH POINT VERT VERTICAL HT HEIGHT	
	*****************	REMOVE CURB & GUTTER	SPOT ELEVATION		•	BOLLARD	HWY HIGHWAY W WEST, WATER W/ WITH ID INSIDE DIAMETER W/O WITHOUT	
		MAJOR CONTOUR	MONUMENT		0	SOIL BORING	IE INVERT ELEVATION WPF WATERPROOF IN INCHES WWM WELDED WIRE MESH	
		MINOR CONTOUR	SURVEY CONTROL POINT			MONITORING WELL  GAS VALVE	INT INTERSECTION, INTERCONNECT  JT JOINT	
	TOP OF SLOPE (H:V)		• REBAR & CAP		10000	SIDEWALK DETECTABLE WARNING SURFACE	LF LINEAR FEET LHT LIGHTING	
	TOE OF SLOPE	CUT / FILL	TOATUM.			ROCK	LP LIGHT POLE LT LEFT	
EXISTING	UTILITY LINETYPES PROPOSED	DESCRIPTION	CITY OF TACOMA DATUM			REMOVE TREE / SHRUB		
			CITY OF TACOMA Horizontal Datum N.A.D. '83/91 Vertical Datum N.G.V.D. '29			TREES	MISCELLANE	OUS CALLOUTS
s		SANITARY SEWER	Vertical Datum N.G.V.D. '29		CLASS	DESCRIPTION		
	ss ss	SANITARY SIDE SEWER	NORTH ARROW		6	STUMP	DETAIL OR SECT	TION NUMBER
D		STORM SEWER	NORTH ARROW		$\otimes$	CLASS 0- CIRCUMFERENCE < 12"	SHEET WHERE I	
6"W	6"W-	WATER LINE				CLASS 0- CIRCUMFERENCE < 12  CLASS 1- CIRCUMFERENCE > 12" OR < 36"	DETAIL OR SECTION NAME	
		WATER SERVICE LINE	EXISTING REMOVE	PROPOSED DESCRIPTION		SEASO 12 STAGOIVII EINEINGE 2 12 OR > 30	DETAIL OR SECTION	DETAIL OR SECTION NUMBER
2"G	2"G	GAS			{	CLASS 2- CIRCUMFERENCE > 36" OR < 72"	SCALE	SHEET WHERE DETAIL OR SECTION
G	G-	GAS SERVICE LINE			W			
OP	OP-	OVERHEAD POWER			( × )	CLASS 3- CIRCUMFERENCE > 72" OR < 127"	DDAEH E I	ELEVATIONS
UP	UP-	UNDERGROUND POWER					PROFILE E	ELEVATIONS
LHT	LHT	STREET LIGHTING			w		EVICTING COADE AT OFNITCH INC	FINISHED GRADE AT CENTERLINE
ттт	т — т	TELECOMMUNICATIONS	SEE INDIVID	UAL SHEETS	l ( × )	CLASS 4- CIRCUMFERENCE > 127", HEIGHT > 30'	EXISTING GRADE AT CENTERLINE	
					Ty M			
IV	TV	CABLE TV LINE			W			0.00
F0	FO	FIBER OPTIC LINE			k ñ ş	OLAGO F. OLDOUMERDENIOS.		$\frac{1}{2}\left \frac{\omega}{\omega}\right $
. // // // // // //		REMOVE/ABANDON UTILITY			X /	CLASS 5- CIRCUMFERENCE > 127", HEIGHT < 30'	10	0+00
· X·	- X-				The state of the s			
					FINAL	DATE SCALE	CITY OF TACOMA	SPEC. NO.
CALL 2 DAYS	BID	KPG	DATUM		FINAL CONSTRUCTION CHECKED	05/24 NTS DESIGNED CHECKED  OF WASHING	ENVIRONMENTAL SERVICE	S DEPARTMENT ES24-0034F
BEFORE YOU DIG		P S O M A S	CITY OF		BY	COT NIM DRAWN PROJECT NAME	WASTEWATER SIDE SEWER IMPROVE	MENTS MCKINLEY ROAD ENV-04018-08
1-800-424-5555	DOCUMENT	<b>Tacoma</b> 2502 Jefferson Avenue Tacoma, WA 98402 253.627.0720	CITY OF TACOMA Horizontal Datum N.A.D. '83/91		DATE FIELD BOOKS	COT WWSS-MCKIN  DRAWING NAME  38363  GISTERS  GISTERS  OF THE CONTROL OF THE CONT	LEGEND & ABBREVIA	PWK-00438-46
		Seattle   Wenatchee   <b>KPG.com</b>	Vertical Datum	R E V I S I O N DATE		ENV-04018-08-05 PS Leg & Abbrev.dwg		2 2 37

CITY OF TACOMA Horizontal Datum N.A.D. '83/91 Vertical Datum N.G.V.D. '29 Seattle | Wenatchee | **KPG.com** 

**Tacoma** 

REVISION DATE APPD

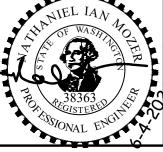

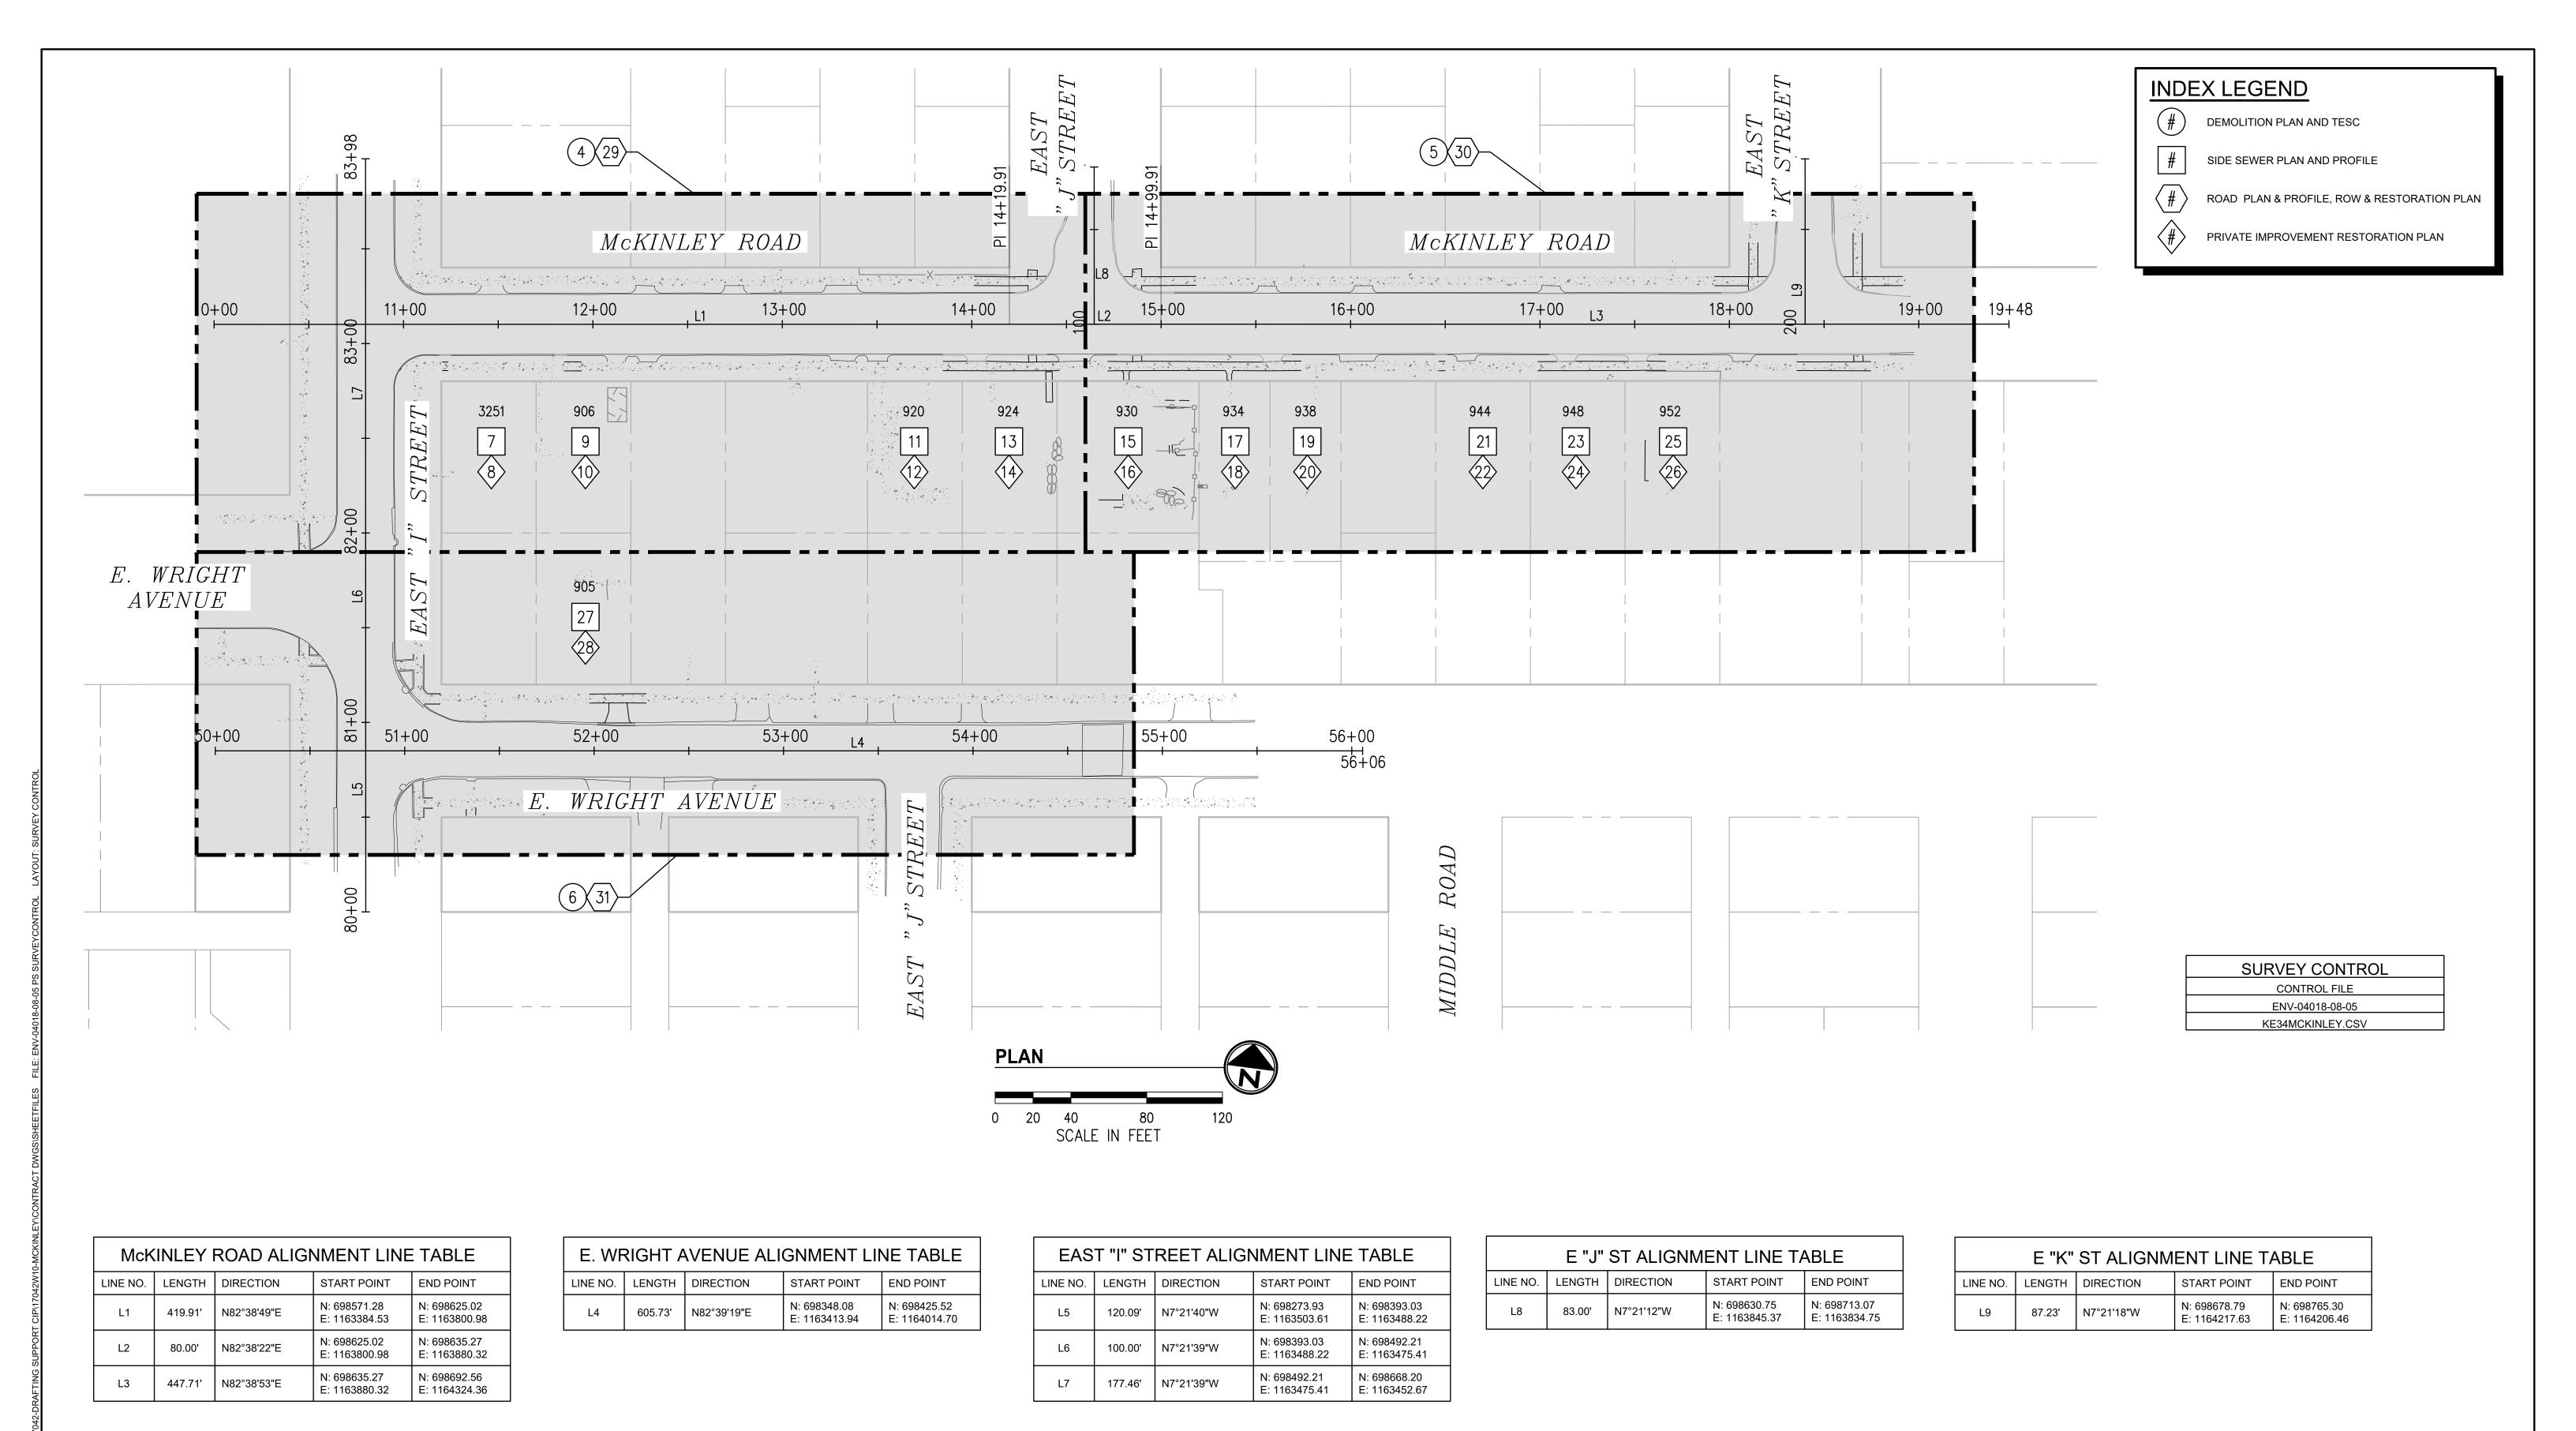


**CALL 2 DAYS BEFORE YOU DIG** 1-800-424-5555

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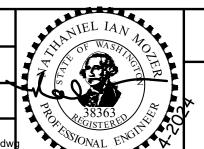






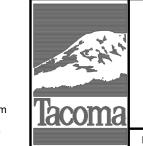

		FINAL CONSTRUCTION CHECKED	DATE <b>05/24</b>	SCALE 1"=40'	نور
			DESIGNED	CHECKED	7.
		BY	EH	NIM	7
		DATE	DRAWN	PROJECT NAME	1
			EH	WWSS-MCKIN	<b>3</b> 3
		FIELD BOOKS	DRAWING NAME		3
DATE	APPD		ENV-04018-08-05 P	S SurveyControl.dw	9




CITY OF TACOMA ENVIRONMENTAL SERVICES DEPARTMENT WASTEWATER SIDE SEWER IMPROVEMENTS MCKINLEY ROAD **ALIGNMENT & SURVEY CONTROL DATA** 

ES24-0034F ENV-04018-08

PWK-00438-46

<sub>0</sub> 37

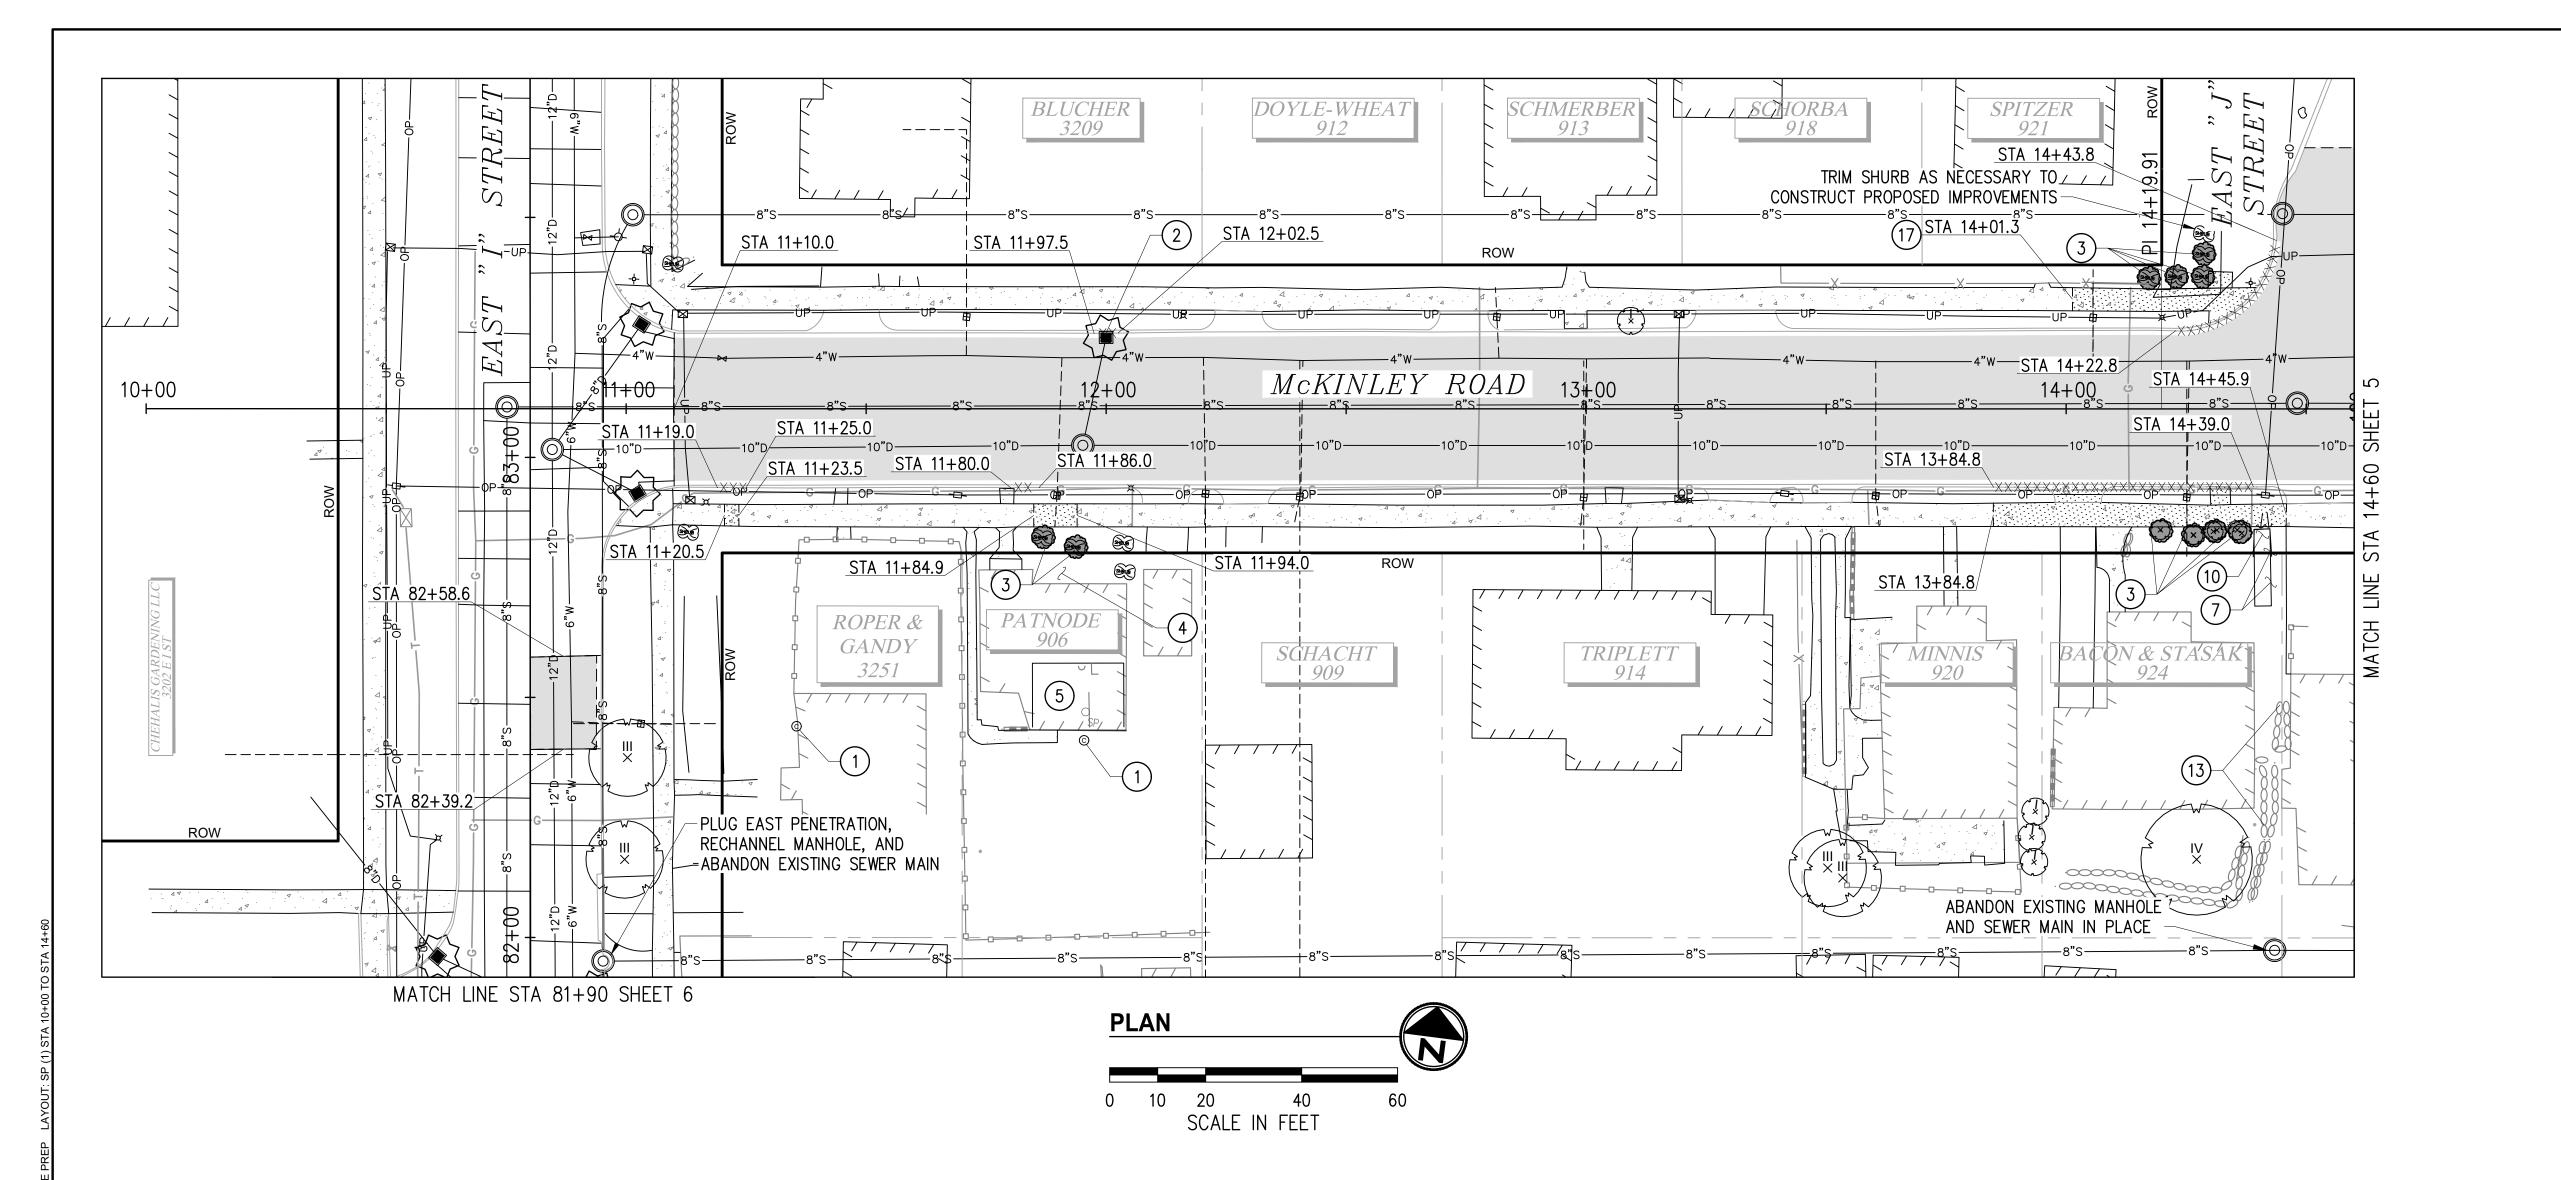


- 1. PRESERVE AND PROTECT ALL IMPROVEMENTS, STRUCTURES, AND VEGETATION NOT MARKED FOR REMOVAL.
- 2. THIS PLAN WAS PREPARED FOR THE CONTRACTOR'S REFERENCE IN LOCATING, PROTECTING, AND AVOIDING CONFLICTS WITH EXISTING UTILITIES AND IMPROVEMENTS. IT IS BASED ON THE BEST AVAILABLE INFORMATION WITHOUT POTHOLING AND IS NOT INTENDED TO BE A COMPLETE RECORD. CONTRACTOR IS RESPONSIBLE FOR INDEPENDENTLY VERIFYING THE LOCATIONS OF ALL UTILITIES AND IMPROVEMENTS PRIOR TO CONSTRUCTION.
- 3. OVERHEAD POWER AND UTILITIES ARE PRESENT THROUGHOUT THE PROJECT SITE.
- 4. CONSTRUCTION ACTIVITIES SHALL BE PHASED AS NECESSARY TO MAINTAIN ACCESS FOR RESIDENTS. DRIVEWAY AND ROADWAY CLOSURES SHALL BE COORDINATED WITH THE ENGINEER AND PROPERTY OWNERS(S) A MINIMUM OF 24 HOURS IN ADVANCE.
- 5. CONTRACTOR SHALL PROVIDE TESC MEASURES IN ADDITION TO THOSE SHOWN IF REQUIRED TO PREVENT SEDIMENT FROM LEAVING THE SITE. CITY SHALL REVIEW AND APPROVE ALL TESC MEASURES PRIOR TO INSTALLATION.
- 6. ACCESS LIMITATIONS MAY REQUIRE THAT SOME OF THIS WORK AND EXCAVATION BE CONDUCTED BY HAND.
- 7. CONTRACTOR SHALL COORDINATE WITH CITY CONSTRUCTION INSPECTOR REGARDING RESTORATIONS ON PRIVATE PROPERTY.

#### **CONSTRUCTION NOTES**


- (1) REMOVE CLEANOUT AND ABANDON/PLUG PIPE 3 FT BELOW GRADE.
- (2) REMOVE AND REPLACE CB FRAME & GRATE.
- (3) REMOVE, SALVAGE, & PROTECT SHRUBS/TREES.
- COORDINATE WITH INSPECTOR IN FIELD TO REMOVE, SALVAGE, & PROTECT LAWN ORNAMENTS/ART.
- SEWER WILL BE RE-ROUTED INTERNALLY WITHIN CRAWLSPACE. SEE SIDE SEWER PLAN & PROFILE SHEET FOR ADDITIONAL INFORMATION REGARDING DEMOLITION INSIDE RESIDENCE.
- (7) PRESERVE & PROTECT PLANTER.
- (10) REMOVE, SALVAGE, & PROTECT LANDSCAPE BORDER.
- (13) REMOVE, SALVAGE, & PROTECT ROCKERY.
- (17) REMOVE, SALVAGE, & PROTECT CHAIN LINK FENCE.

#### **LEGEND**

EXISTING CEMENT CONCRETE SIDEWALK

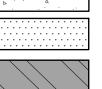


REMOVE CEMENT CONCRETE (TYPE II, CLASS C6)

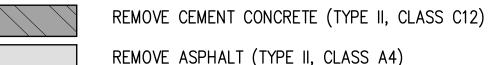

-xxxxxxxxxxxxxxx - REMOVE CURB & GUTTER



ABANDON PIPE PER SPECIAL PROVISIONS

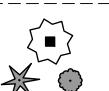

INLET PROTECTION

FULL DEPTH SAWCUT

REMOVE TREE/SHRUB

CALL 2 DAYS **BEFORE YOU DIG** 1-800-424-5555

BID DOCUMENT



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WWSS-MCKIN ENV-04018-08-05 PS Site Prep.dwg

05/24

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EΗ

1"=20'




ENVIRONMENTAL SERVICES DEPARTMENT

STA 10+00 TO STA 14+60

ENV-04018-08 PWK-00438-46

ES24-0034F

or 37 4

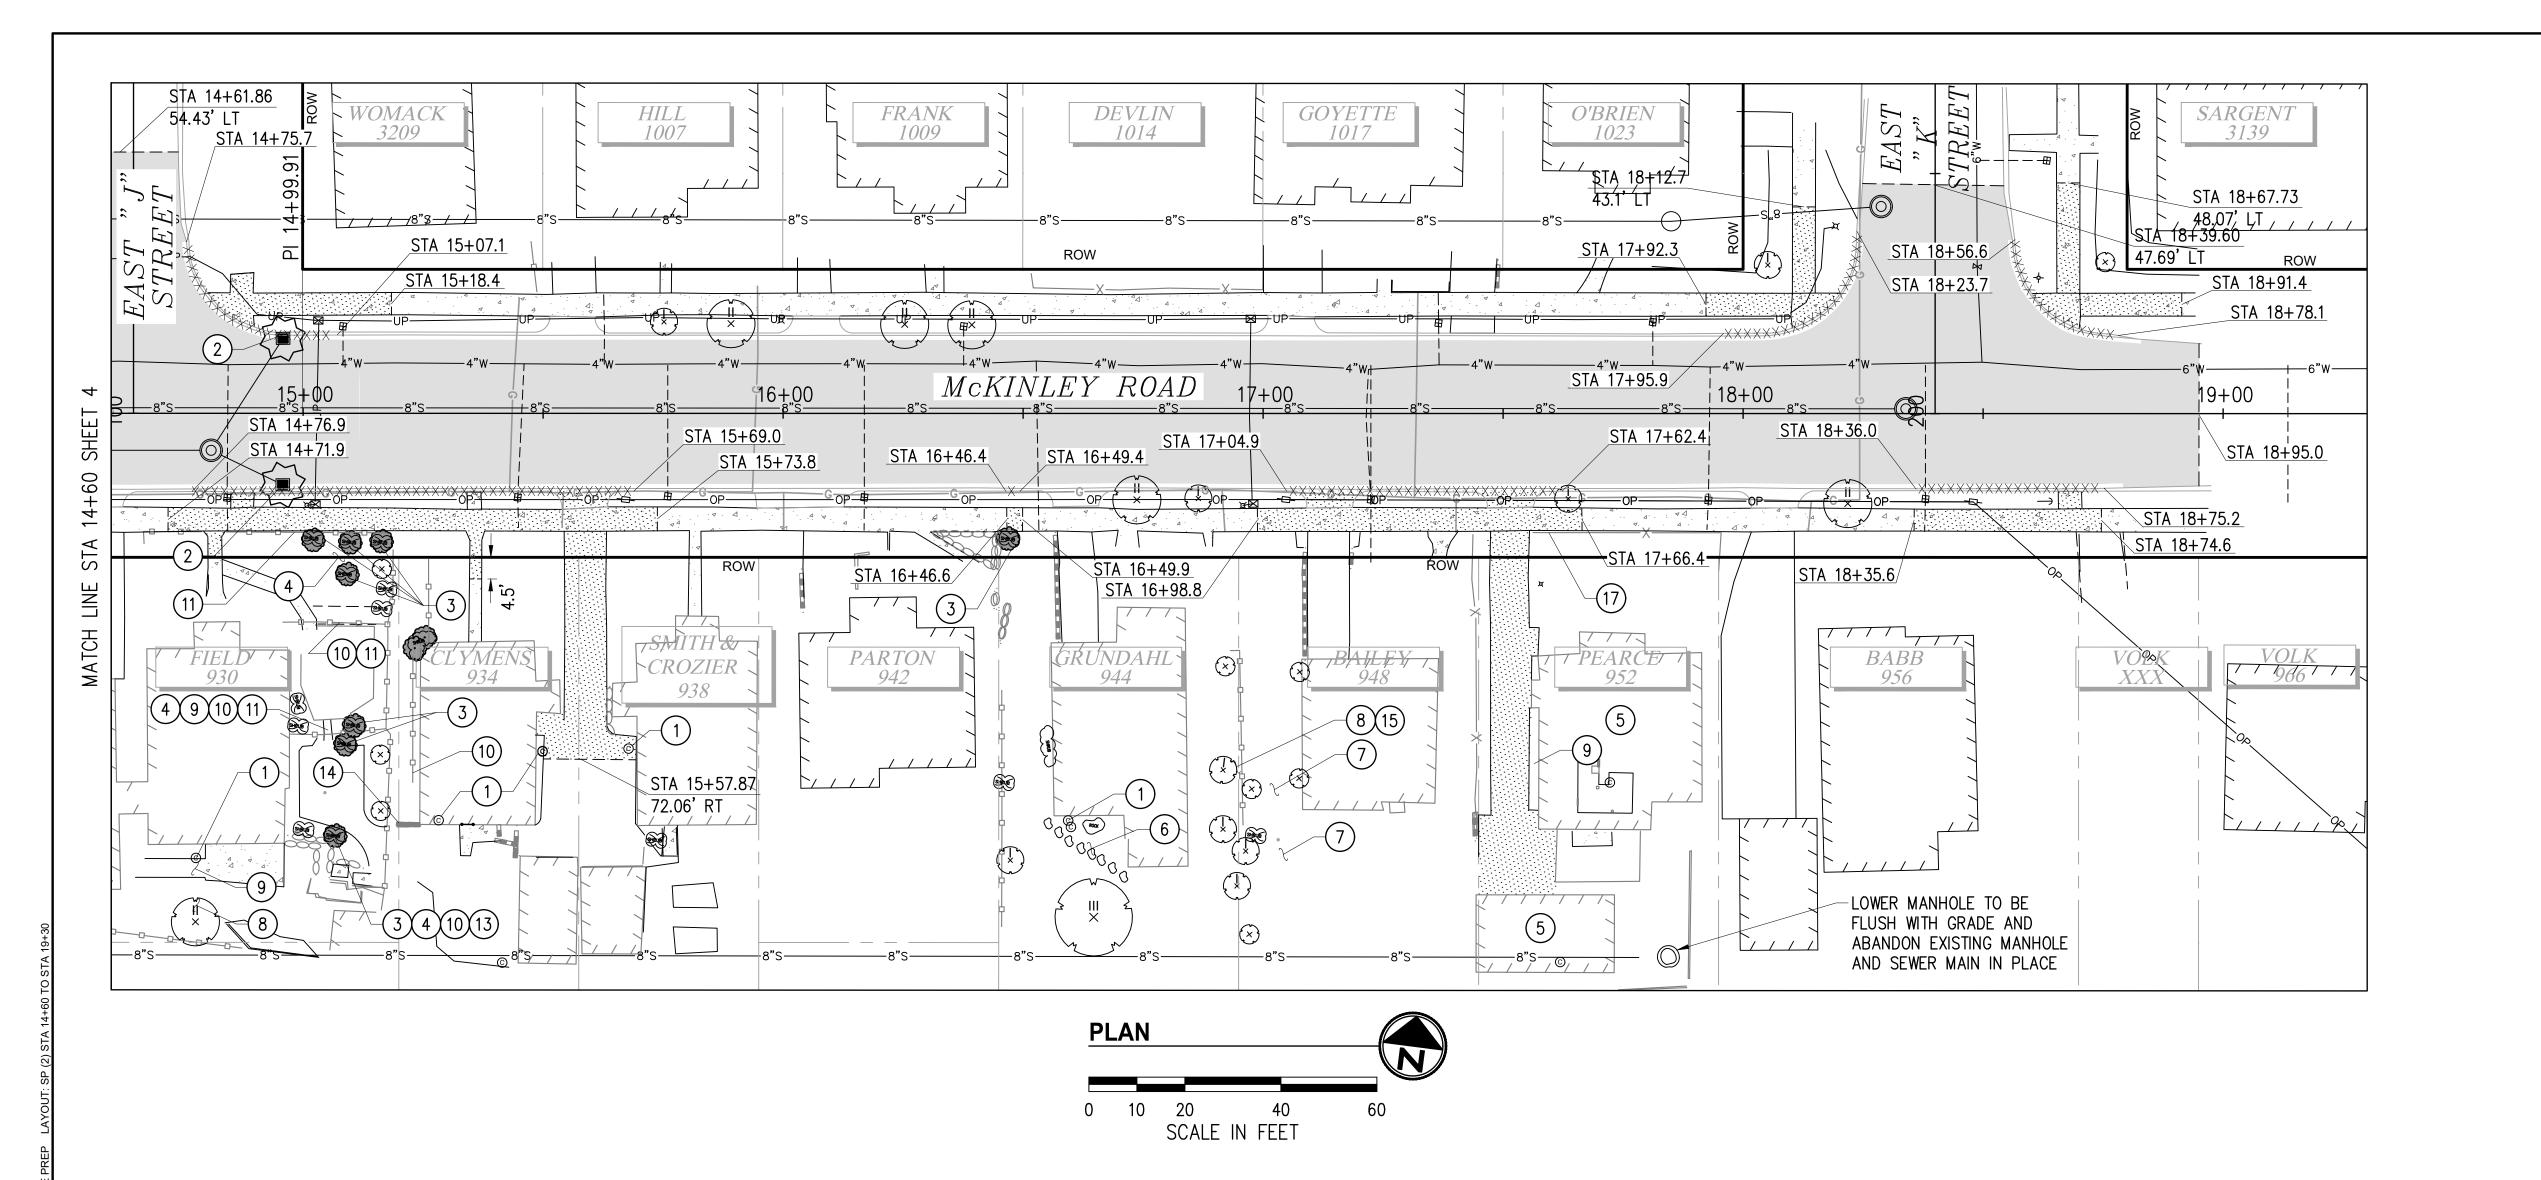


- 1. PRESERVE AND PROTECT ALL IMPROVEMENTS, STRUCTURES, AND VEGETATION NOT MARKED FOR REMOVAL.
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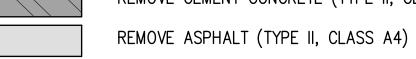
#### **CONSTRUCTION NOTES**

- (1) REMOVE CLEANOUT AND ABANDON/PLUG PIPE 3 FT BELOW GRADE.
- (2) REMOVE AND REPLACE CB FRAME & GRATE.
- 3 REMOVE, SALVAGE, & PROTECT SHRUBS/TREES.
- COORDINATE WITH INSPECTOR IN FIELD TO REMOVE, SALVAGE, & PROTECT LAWN ORNAMENTS/ART.
- SEWER WILL BE RE-ROUTED INTERNALLY WITHIN CRAWLSPACE. SEE 5 SIDE SEWER PLAN & PROFILE SHEET FOR ADDITIONAL INFORMATION REGARDING DEMOLITION INSIDE RESIDENCE.
- (6) REMOVE, SALVAGE, & PROTECT FLAG STONE(S).
- (7) PRESERVE & PROTECT PLANTER.
- 8 PRESERVE & PROTECT TREE ROOTS. HAND EXCAVATE PRIOR TO SIDE SEWER EXCAVATION PER THE ARBORIST'S RECOMMENDATIONS.
- (9) REMOVE, SALVAGE, & PROTECT BRICK PAVERS.
- (10) REMOVE, SALVAGE, & PROTECT LANDSCAPE BORDER.
- (11) REMOVE, SALVAGE, & PROTECT WOOD FENCE & GATE.
- (13) REMOVE, SALVAGE, & PROTECT ROCKERY.
- (14) REMOVE AND DISPOSE OF CONC RETAINING WALL.
- (15) PRESERVE & PROTECT TREE/SHRUB.
- (17) REMOVE, SALVAGE, & PROTECT CHAIN LINK FENCE.

#### **LEGEND**

EXISTING CEMENT CONCRETE SIDEWALK



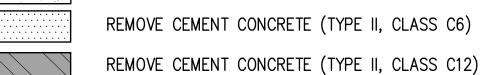

-XXXXXXXXXXXXXXX REMOVE CURB & GUTTER

ABANDON PIPE PER SPECIAL PROVISIONS \*/\*/\*/\*/\*/\*/\*/\*/\*/\* SECTION 7-08

\_\_\_\_ FULL DEPTH SAWCUT



REMOVE TREE/SHRUB

INLET PROTECTION

CALL 2 DAYS **BEFORE YOU DIG** 1-800-424-5555

BID **DOCUMENT** 




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	NO	REVISION	DATE	APPD		ENV-04018-08-05 P	S Site Prep.dwg
<u>lacoma</u>					FIELD BOOKS	DRAWING NAME	
Theorem					DATE	EH	WWSS-MCKIN
					D.4.TE	DRAWN	PROJECT NAME
					BY	EH	NIM
200						DESIGNED	CHECKED
					CHECKED	05/24	1"=20'
					CONSTRUCTION	DAIL	SCALL






WASTEWATER SIDE SEWER IMPROVEMENTS MCKINLEY ROAD **DEMOLITION PLAN & TESC** STA 14+60 TO STA 19+30

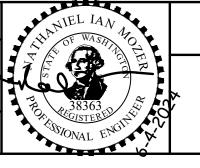ENV-04018-08 PWK-00438-46

ES24-0034F

<sub>○</sub> 37

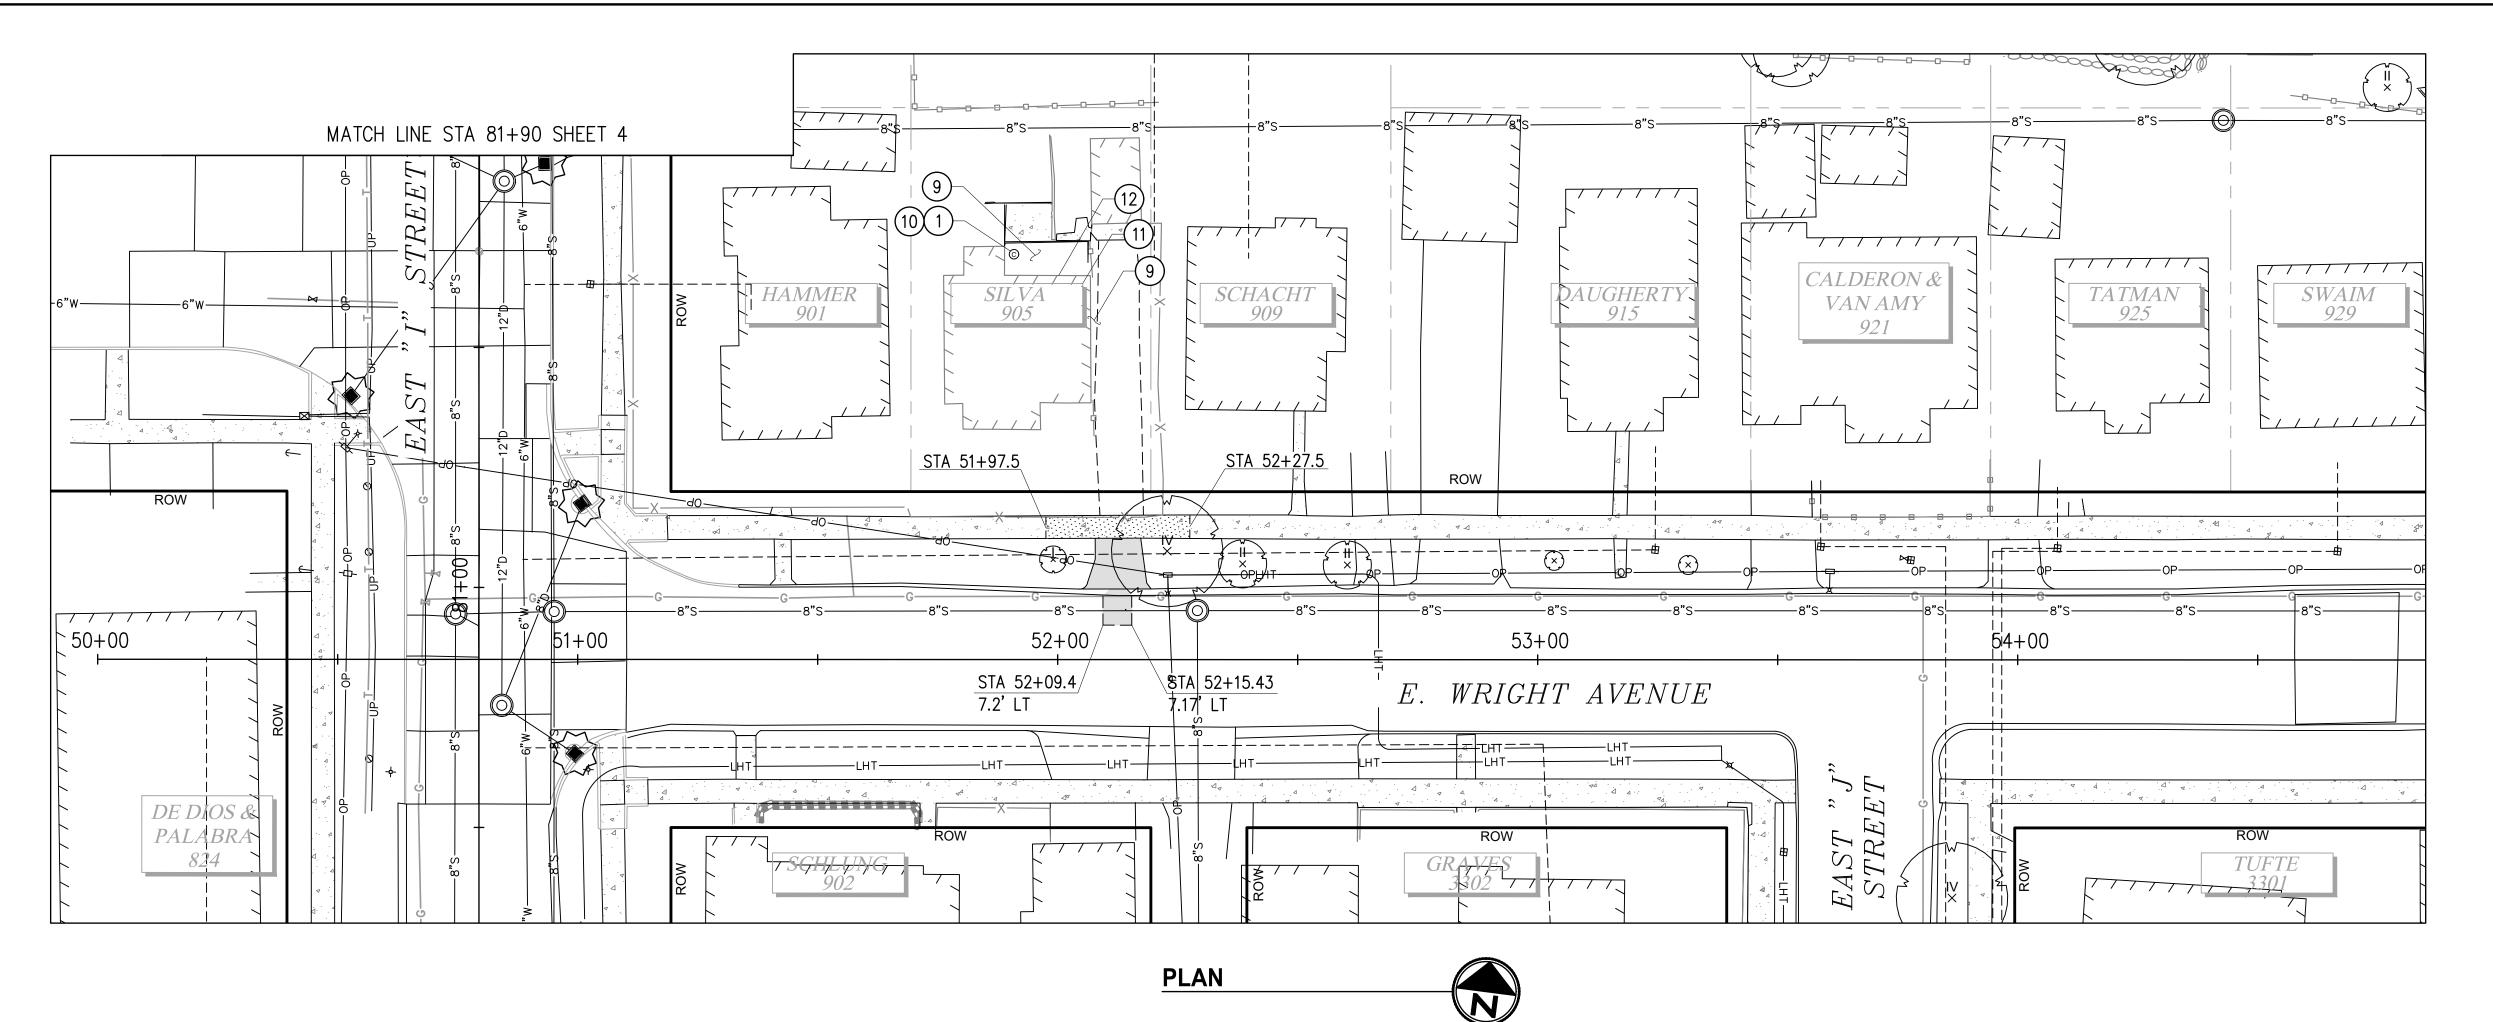

20

REVISION

SCALE IN FEET

#### **GENERAL NOTES**

- 1. PRESERVE AND PROTECT ALL IMPROVEMENTS, STRUCTURES, AND VEGETATION NOT MARKED FOR REMOVAL.
- 2. THIS PLAN WAS PREPARED FOR THE CONTRACTOR'S REFERENCE IN LOCATING, PROTECTING, AND AVOIDING CONFLICTS WITH EXISTING UTILITIES AND IMPROVEMENTS. IT IS BASED ON THE BEST AVAILABLE INFORMATION WITHOUT POTHOLING AND IS NOT INTENDED TO BE A COMPLETE RECORD. CONTRACTOR IS RESPONSIBLE FOR INDEPENDENTLY VERIFYING THE LOCATIONS OF ALL UTILITIES AND IMPROVEMENTS PRIOR TO CONSTRUCTION.
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#### **CONSTRUCTION NOTES**

- 1) REMOVE CLEANOUT AND ABANDON/PLUG PIPE 3 FT BELOW GRADE.
- (9) REMOVE, SALVAGE, & PROTECT BRICK PAVERS.
- (10) REMOVE, SALVAGE, & PROTECT LANDSCAPE BORDER.
- (11) REMOVE, SALVAGE, & PROTECT WOOD FENCE & GATE.
- (12) REMOVE, SALVAGE, & PROTECT WOODEN STEPS.

#### **LEGEND**

EXISTING CEMENT CONCRETE SIDEWALK

REMOVE CEMENT CONCRETE (TYPE II, CLASS C6) REMOVE CEMENT CONCRETE (TYPE II, CLASS C12)




REMOVE ASPHALT (TYPE II, CLASS A4)

·xxxxxxxxxxxxxx REMOVE CURB & GUTTER

-/-/-/-/-/-/-/-/-/-/-/-/-/-/-- SECTION 7-08

ABANDON PIPE PER SPECIAL PROVISIONS

\_\_\_\_ FULL DEPTH SAWCUT

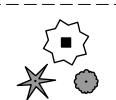

INLET PROTECTION REMOVE TREE/SHRUB

**CALL 2 DAYS BEFORE YOU DIG** 1-800-424-5555


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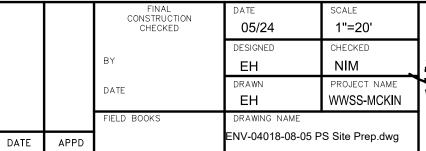


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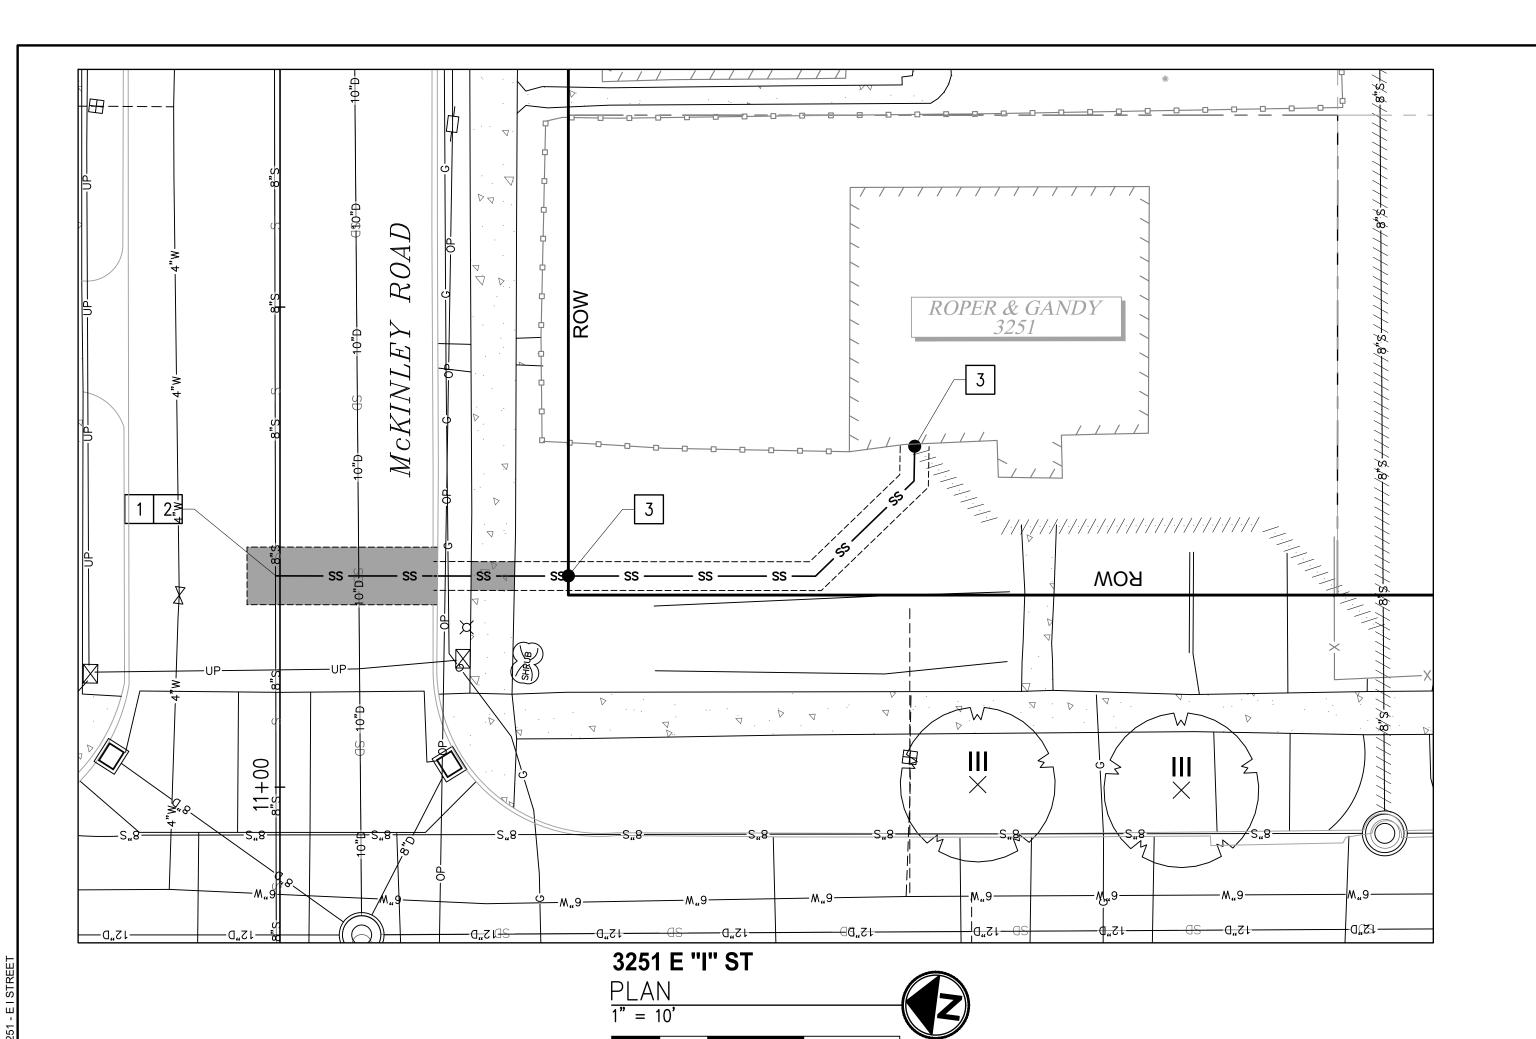







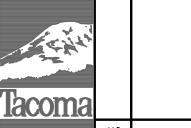

ES24-0034F



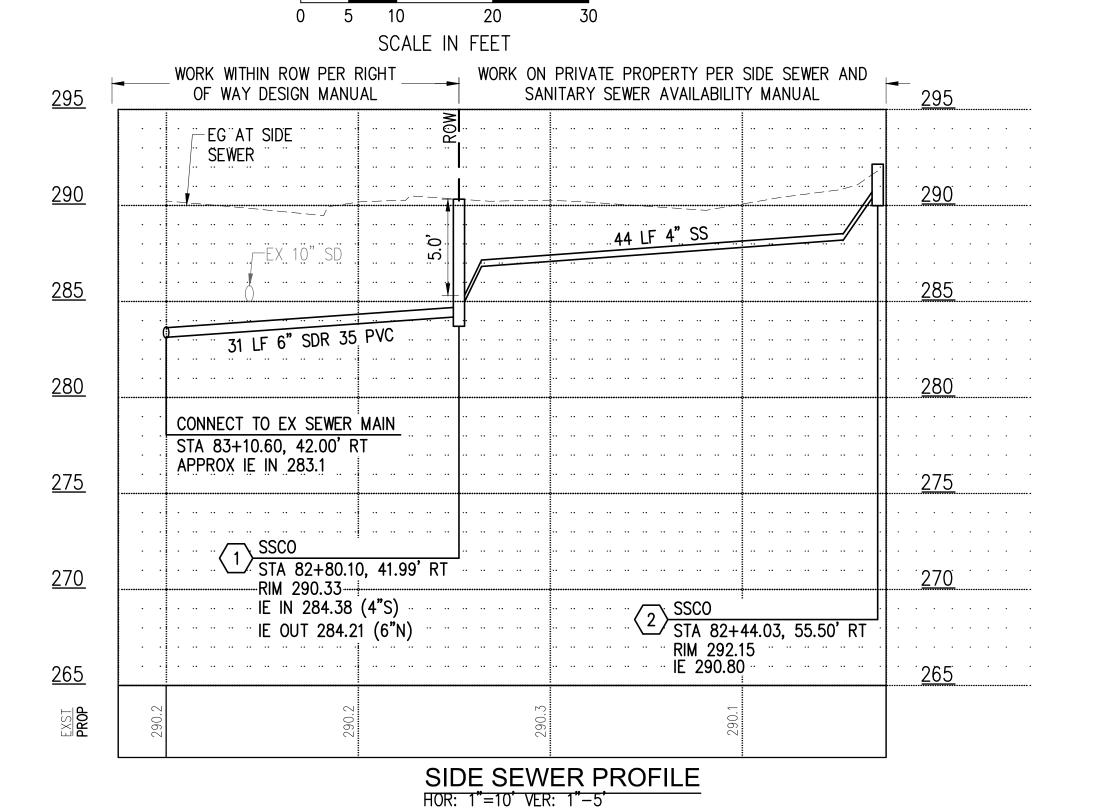

- 1 CONNECT TO EXISTING SEWER MAIN PER COT STANDARD PLAN SU-23.
- 2 CONSTRUCT PVC SIDE SEWER PER THE COT SIDE SEWER AND SANITARY SEWER AVAILABILITY MANUAL.
- 3 CONSTRUCT CLEANOUT PER COT STANDARD PLAN SU-24.

#### **LEGEND**

TEMPORARY HMA PATCH PER DETAIL 2, SHEET 37

TEMPORARY CSTC TRENCH PATCH PER DETAIL 3, SHEET 37

—— ss —— SIDE SEWER

- SS CLEANOUT
- SS CLEANOUT NUMBER

#### SIDE SEWER CONSTRUCTION STANDARDS

- 1. PIPE SIZE SHALL BE A MINIMUM OF 6" WITHIN ROW AND MINIMUM OF 4" ON PRIVATE PROPERTY.
- 2. SIDE SEWER MINIMUM PIPE SLOPE IS 2.0%.
- 3. SIDE SEWERS SHALL HAVE A MINIMUM DEPTH OF 5' AT THE ROW
- 4. CLEANOUTS SHALL BE REQUIRED AT THE FOLLOWING LOCATIONS: -APPROXIMATELY 2' FROM THE BUILDING AT THE CHANGE FROM BUILDING DRAIN TO SIDE SEWER. -EVERY 135 DEGREES OF TOTAL BEND (INCLUDING HORZ. AND VERT.). -EVERY 100' OF PIPE RUN.
  - -EVERY CHANGE OF PIPE SIZE.
- -AT THE PROPERTY LINE.
- 5. PIPE SHALL HAVE MINIMUM DEPTH OF COVER OF 3' IN DRIVING

#### **GENERAL NOTES**

- 1. THE HORIZONTAL AND VERTICAL SIDE SEWER CONFIGURATION SHOWN ON THIS SHEET IS APPROXIMATE BASED ON THE INFORMATION AVAILABLE DURING DESIGN. THE CONTRACTOR MAY, WITH THE APPROVAL OF THE CONSTRUCTION INSPECTOR, ADJUST THE SIDE SEWER ALIGNMENT AS NEEDED TO BETTER ACCOMMODATE CONSTRUCTION METHODS AND CONDITIONS EXPERIENCED DURING CONSTRUCTION.
- 2. ALL EXISTING UTILITY INFORMATION INCLUDING MATERIAL, DEPTH, AND LOCATION ARE BASED ON AVAILABLE INFORMATION WITHOUT POTHOLING AND IS SOLELY FOR THE CONTRACTOR'S BENEFIT. INVERT ELEVATIONS FOR UTILITY CROSSINGS SHOWN ON PROFILES ARE ESTIMATED BASED ON RECORD DRAWINGS, GIS, OR OTHER DATA AND MAY NOT BE ACCURATE. INVERT ELEVATIONS FOR SOME UTILITY CROSSINGS ARE NOT AVAILABLE; THESE UTILITIES ARE SHOWN ON THE PROFILES IN THEIR APPROX. HORIZONTAL LOCATION TO ALERI THE CONTRACTOR OF THEIR EXISTENCE. THE CONTRACTOR SHALL POTHOLE UTILITY CROSSINGS & CONNECTION POINTS AT THE LOCATIONS SPECIFIED HEREIN A MINIMUM OF 5 WORKING DAYS PRIOR TO BEGINNING UTILITY IMPROVEMENTS TO VERIFY HORIZONTAL/VERTICAL LOCATION AND MATERIAL. CONTRACTOR SHALL NOTIFY THE ENGINEER IMMEDIATELY IN THE EVENT OF CONFLICT.
- 3. CONTRACTOR SHALL BE RESPONSIBLE FOR DETERMINING ALL PIPE AND FITTINGS REQUIRED TO REALIGN PLUMBING WITHIN EXISTING BASEMENTS/CRAWL SPACES WHERE SPECIFIED ON THE PLANS.
- 4. SIDE SEWERS WITHIN 10' HORIZONTALLY OR 18" VERTICALLY OF EXISTING WATER SERVICE SHALL BE CONSTRUCTED WITH C900 PVC SEWER PIPE.
- 5. THE EXISTING SIDE SEWER PIPE MATERIAL(S) IS UNKNOWN. CONTRACTOR SHALL BE RESPONSIBLE FOR DETERMINING EXISTING PIPE MATERIALS AND PROVIDING AN APPROPRIATE COUPLING TO TRANSITION FROM EXISTING TO PROPOSED SIDE SEWER PIPE
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- 7. CONSTRUCTION WILL REQUIRE EXCAVATION IMMEDIATELY ADJACENT TO EXISTING BUILDING AND STRUCTURES, THE MAJORITY OF WHICH WERE CONSTRUCTED IN THE 1920'S. IT IS THE CONTRACTOR'S RESPONSIBILITY TO PRESERVE AND PROTECT ALL BUILDINGS AND STRUCTURES AND TO MAKE SURE CONSTRUCTION METHODS, SHORING METHODS, AND COMPACTION METHODS ARE APPROPRIATE GIVEN THE LOCATION OF THE CONSTRUCTION AREA.
- 8. CONTRACTOR SHALL BE RESPONSIBLE FOR LOCATING EXISTING UTILITIES ON PRIVATE PROPERTY.

CALL 2 DAYS **BEFORE YOU DIG** 1-800-424-5555

BID **DOCUMENT** 



Tacoma, WA 98402 253.627.0720


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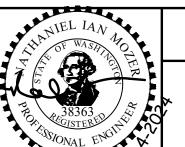






CONSTRUCTION CHECKED 05/24 AS NOTED WWSS-MCKIN NV-04018-08-05 Side Sewers 01.d DATE



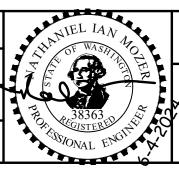


CITY OF TACOMA ENVIRONMENTAL SERVICES DEPARTMENT

WASTEWATER SIDE SEWER IMPROVEMENTS MCKINLEY ROAD SIDE SEWER PLAN + PROFILE & TEMPORARY RESTORATION PLAN 3251 - EAST I STREET

ENV-04018-08 PWK-00438-46

ES24-0034F

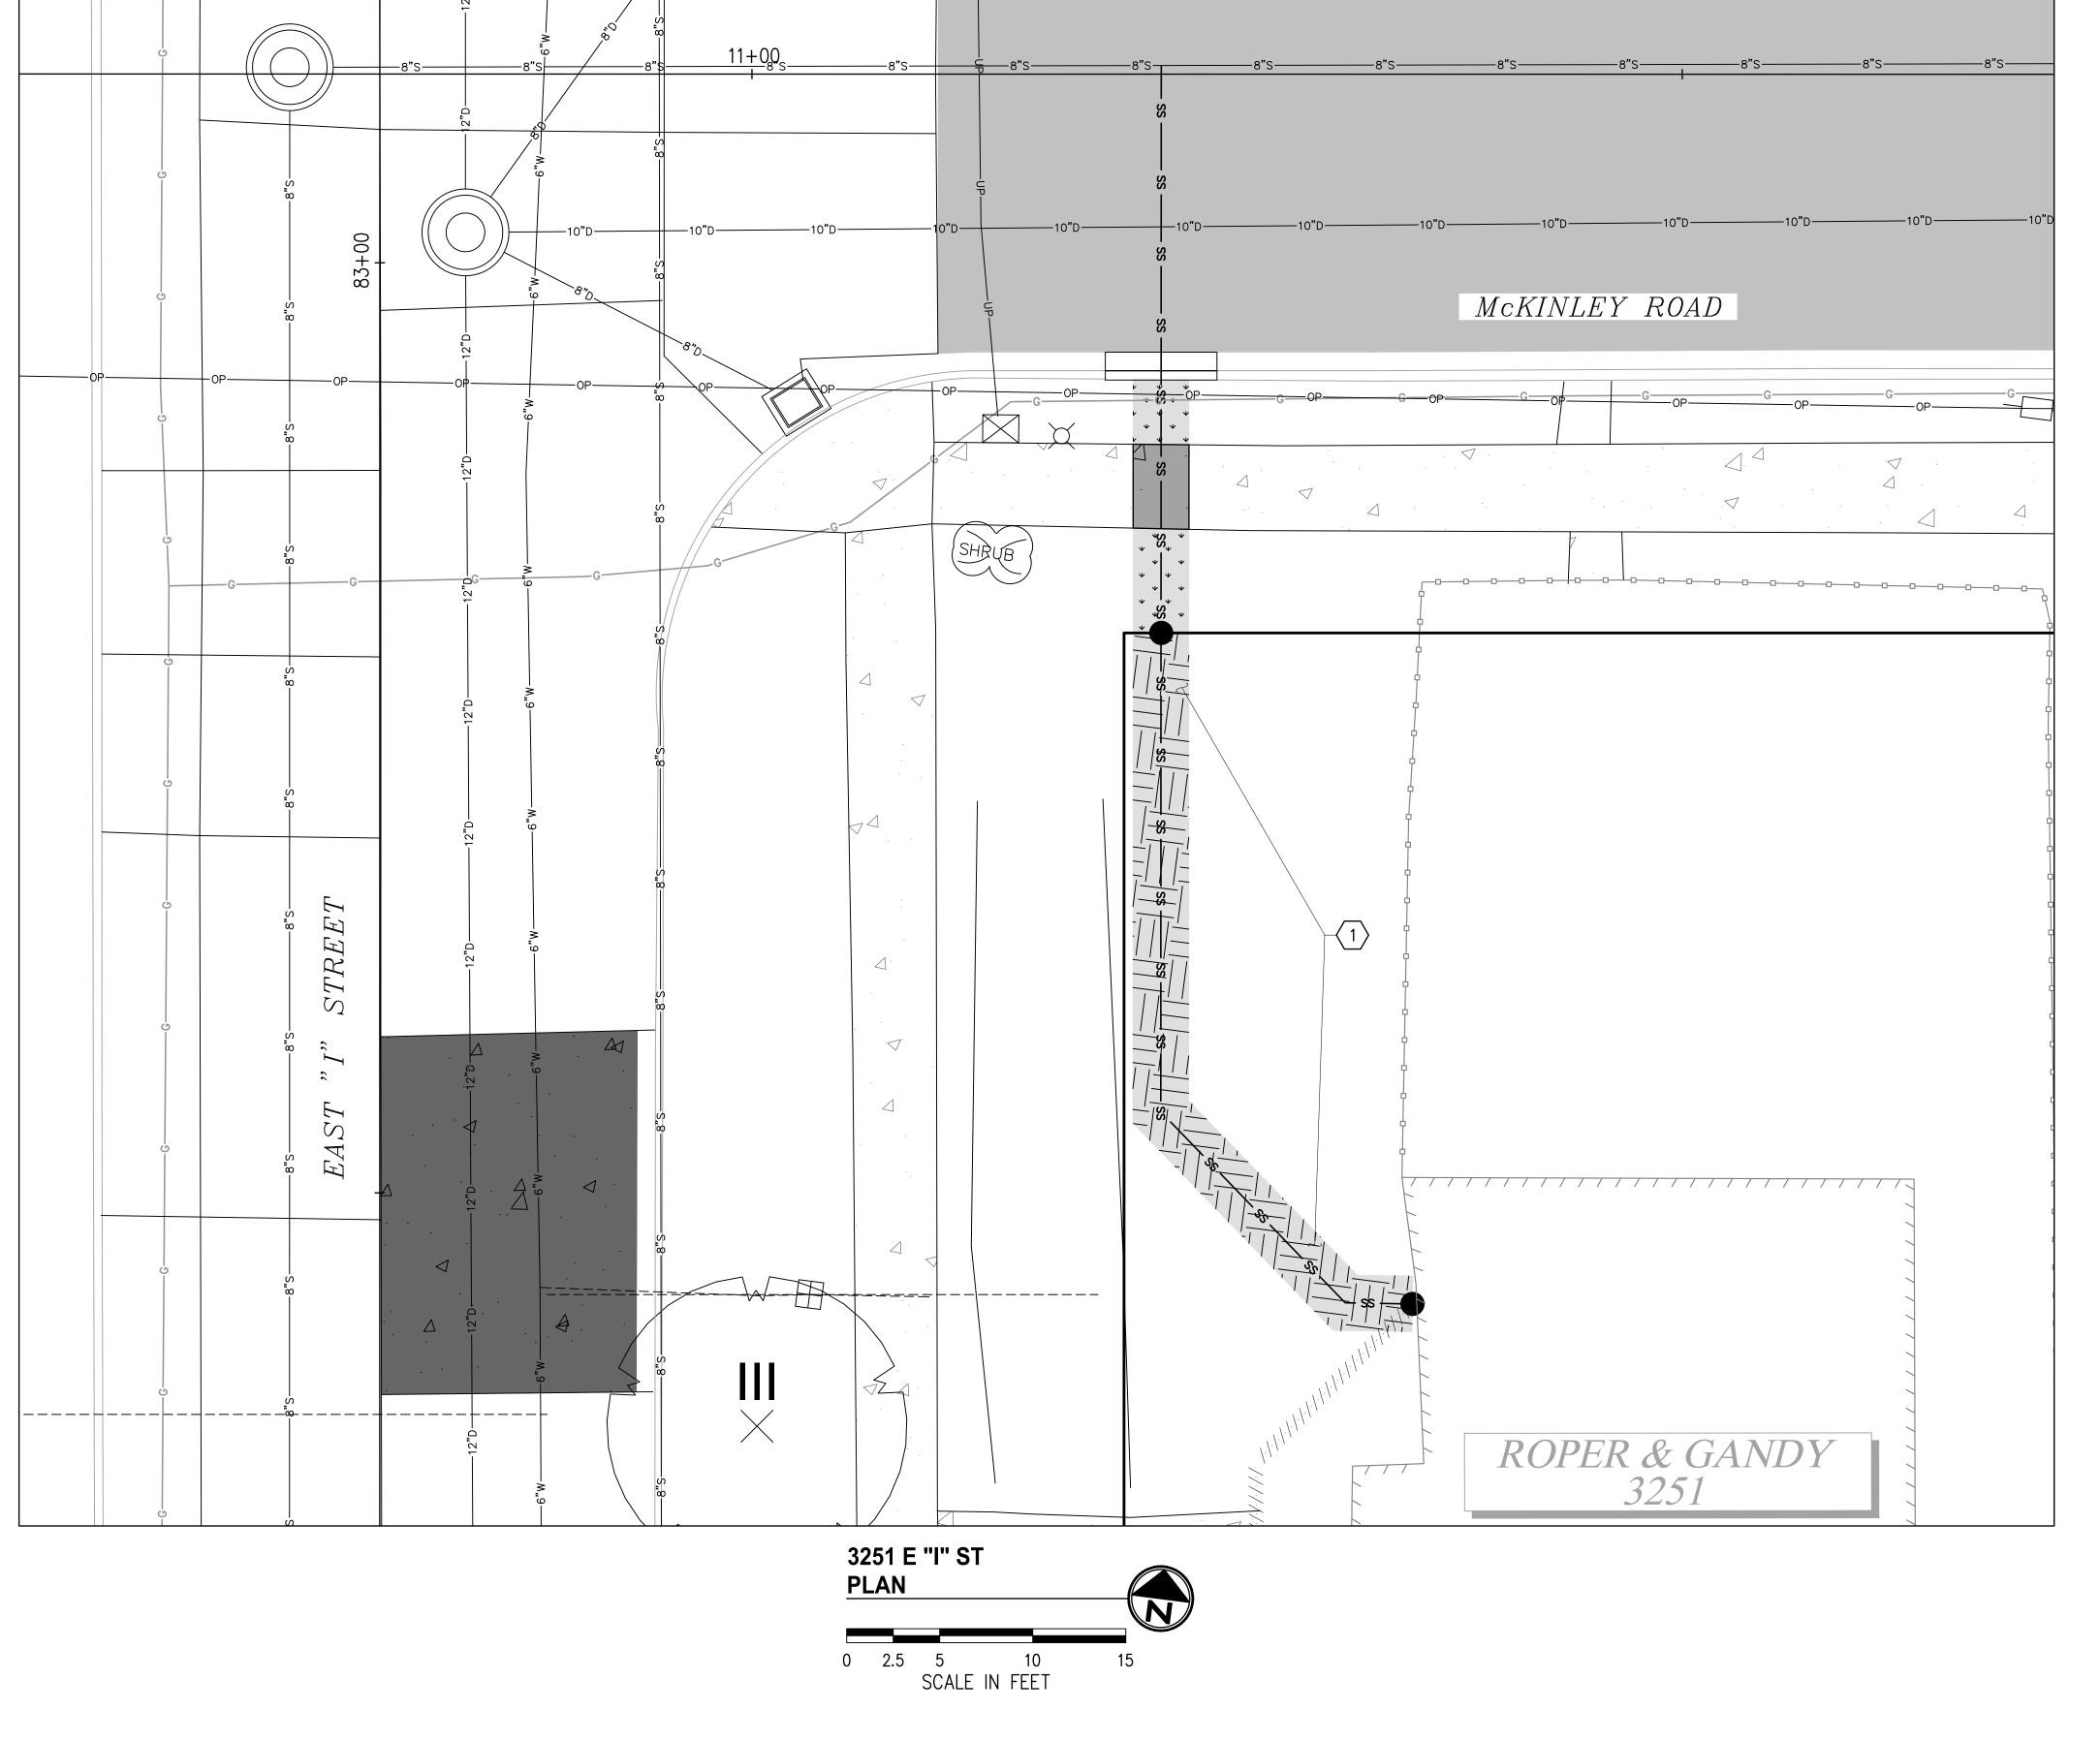

- 1. CONTRACTOR SHALL COORDINATE DIRECTLY WITH PROPERTY OWNER AND CITY INSPECTOR TO CONFIRM THE LOCATIONS AND TYPES OF MATERIALS TO USE DURING RESTORATION PRIOR TO BEGINNING THE
- 2. FOR RESTORATION WITHIN ROW SEE SHEETS 29-31.

#### **CONSTRUCTION NOTES**

1 RESTORE LAWN PER RESTORATION TABLE, SHEET 37.

#### **LEGEND**

HARD SURFACE RESTORATION ON PRIVATE PROPERTY, SEE NOTES, THIS SHEET

SOFT SURFACE RESTORATION ON PRIVATE PROPERTY, SEE NOTES, THIS SHEET

PLANTER STRIP/LAWN WITHIN ROW

**CALL 2 DAYS BEFORE YOU DIG** 1-800-424-5555


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**KPG** PSOMAS Tacoma 2502 Jefferson Avenue Tacoma, WA 98402 253.627.0720

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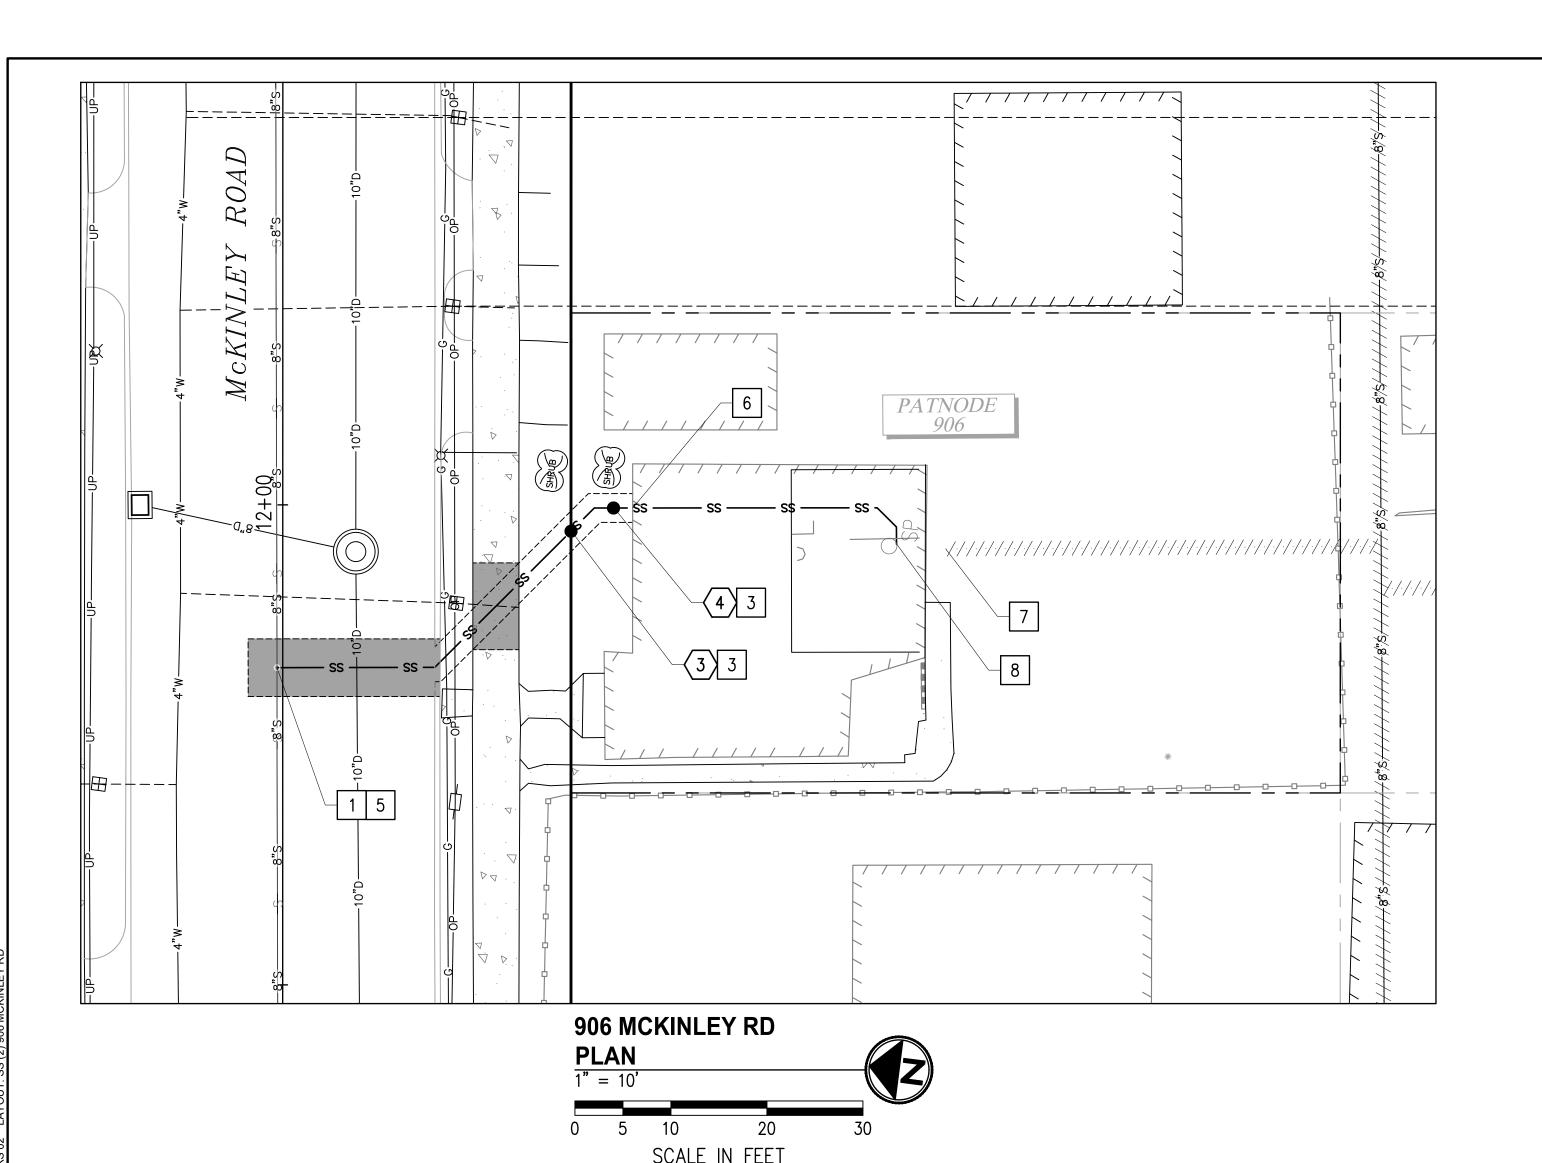



CITY OF TACOMA
ENVIRONMENTAL SERVICES DEPARTMENT

WASTEWATER SIDE SEWER IMPROVEMENTS MCKINLEY ROAD PRIVATE IMPROVEMENT RESTORATION PLAN 3251 - EAST I STREET

ENV-04018-08 PWK-00438-46

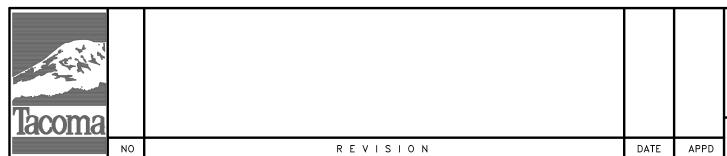ES24-0034F



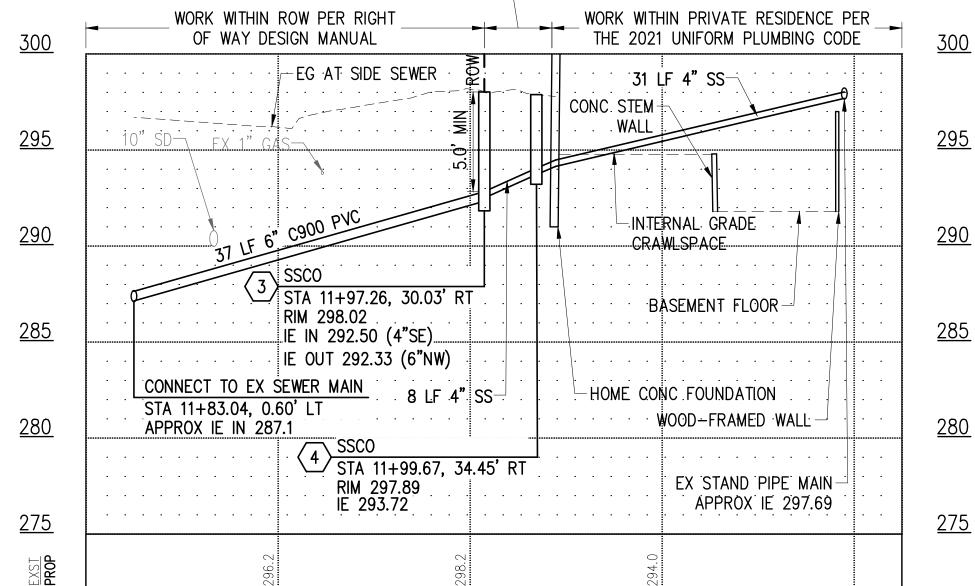

- 1 CONNECT TO EXISTING SEWER MAIN PER COT STANDARD PLAN SU-23.
- 3 CONSTRUCT CLEANOUT PER COT STANDARD PLAN SU-24.
- 5 CONSTRUCT C900 PVC SIDE SEWER PER THE COT SIDE SEWER AND SANITARY AVAILABILITY MANUAL.
- 6 CORE THROUGH EXISTING FOUNDATION AND INSTALL APPROPRIATELY SIZED LINK SEAL TO PROVIDE WATER TIGHT PENETRATION.
- 7 REMOVE EXISTING CLEANOUT AND CAP ABANDONED PIPE 3' BELOW
- 8 INTERCEPT EXISTING SIDE SEWER AND CAP END OF ABANDONED PIPE.

#### **LEGEND**



TEMPORARY HMA PATCH PER DETAIL 2. SHEET 37



TEMPORARY CSTC TRENCH PATCH PER DETAIL 3, SHEET 37



— ss — SIDE SEWER



SS CLEANOUT NUMBER

SS CLEANOUT

#### SIDE SEWER CONSTRUCTION STANDARDS

- 1. PIPE SIZE SHALL BE A MINIMUM OF 6" WITHIN ROW AND MINIMUM OF 4" ON PRIVATE PROPERTY.
- 2. SIDE SEWER MINIMUM PIPE SLOPE IS 2.0%.
- 3. SIDE SEWERS SHALL HAVE A MINIMUM DEPTH OF 5' AT THE ROW
- 4. CLEANOUTS SHALL BE REQUIRED AT THE FOLLOWING LOCATIONS: -APPROXIMATELY 2' FROM THE BUILDING AT THE CHANGE FROM BUILDING DRAIN TO SIDE SEWER. -EVERY 135 DEGREES OF TOTAL BEND (INCLUDING HORZ. AND VERT.).
- -EVERY 100' OF PIPE RUN. -EVERY CHANGE OF PIPE SIZE. -AT THE PROPERTY LINE.
- 5. PIPE SHALL HAVE MINIMUM DEPTH OF COVER OF 3' IN DRIVING AREAS.

#### **GENERAL NOTES**

- 1. THE HORIZONTAL AND VERTICAL SIDE SEWER CONFIGURATION SHOWN ON THIS SHEET IS APPROXIMATE BASED ON THE INFORMATION AVAILABLE DURING DESIGN. THE CONTRACTOR MAY, WITH THE APPROVAL OF THE CONSTRUCTION INSPECTOR, ADJUST THE SIDE SEWER ALIGNMENT AS NEEDED TO BETTER ACCOMMODATE CONSTRUCTION METHODS AND CONDITIONS EXPERIENCED DURING CONSTRUCTION.
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- 8. CONTRACTOR SHALL BE RESPONSIBLE FOR LOCATING EXISTING UTILITIES ON PRIVATE PROPERTY.

- 1. FINISHED FLOOR ELEVATIONS INTERNAL WITHIN THE HOME SHOWN ON THE PROFILE ARE BASED ON LIMITED SURVEY AND ARE APPROXIMATE.
- 2. BOTTOM OF FLOOR JOIST ELEVATION IS APPROXIMATELY 298.16'.

CALL 2 DAYS **BEFORE YOU DIG** 1-800-424-5555

BID **DOCUMENT** 



SIDE SEWER PROFILE

HOR: 1"=10' VER: 1"-5'

2502 Jefferson Avenue





SANITARY SEWER AVAILABILITY MANUAL





FINAL CONSTRUCTION CHECKED 05/24 AS NOTED EΗ WWSS-MCKIN EΗ :NV-04018-08-05 PS Side Sewers 0 DATE APPD







WASTEWATER SIDE SEWER IMPROVEMENTS MCKINLEY ROAD SIDE SEWER PLAN + PROFILE & TEMPORARY RESTORATION PLAN 906 MCKINLEY ROAD

ENV-04018-08 PWK-00438-46

ES24-0034F

<sub>05</sub> 37

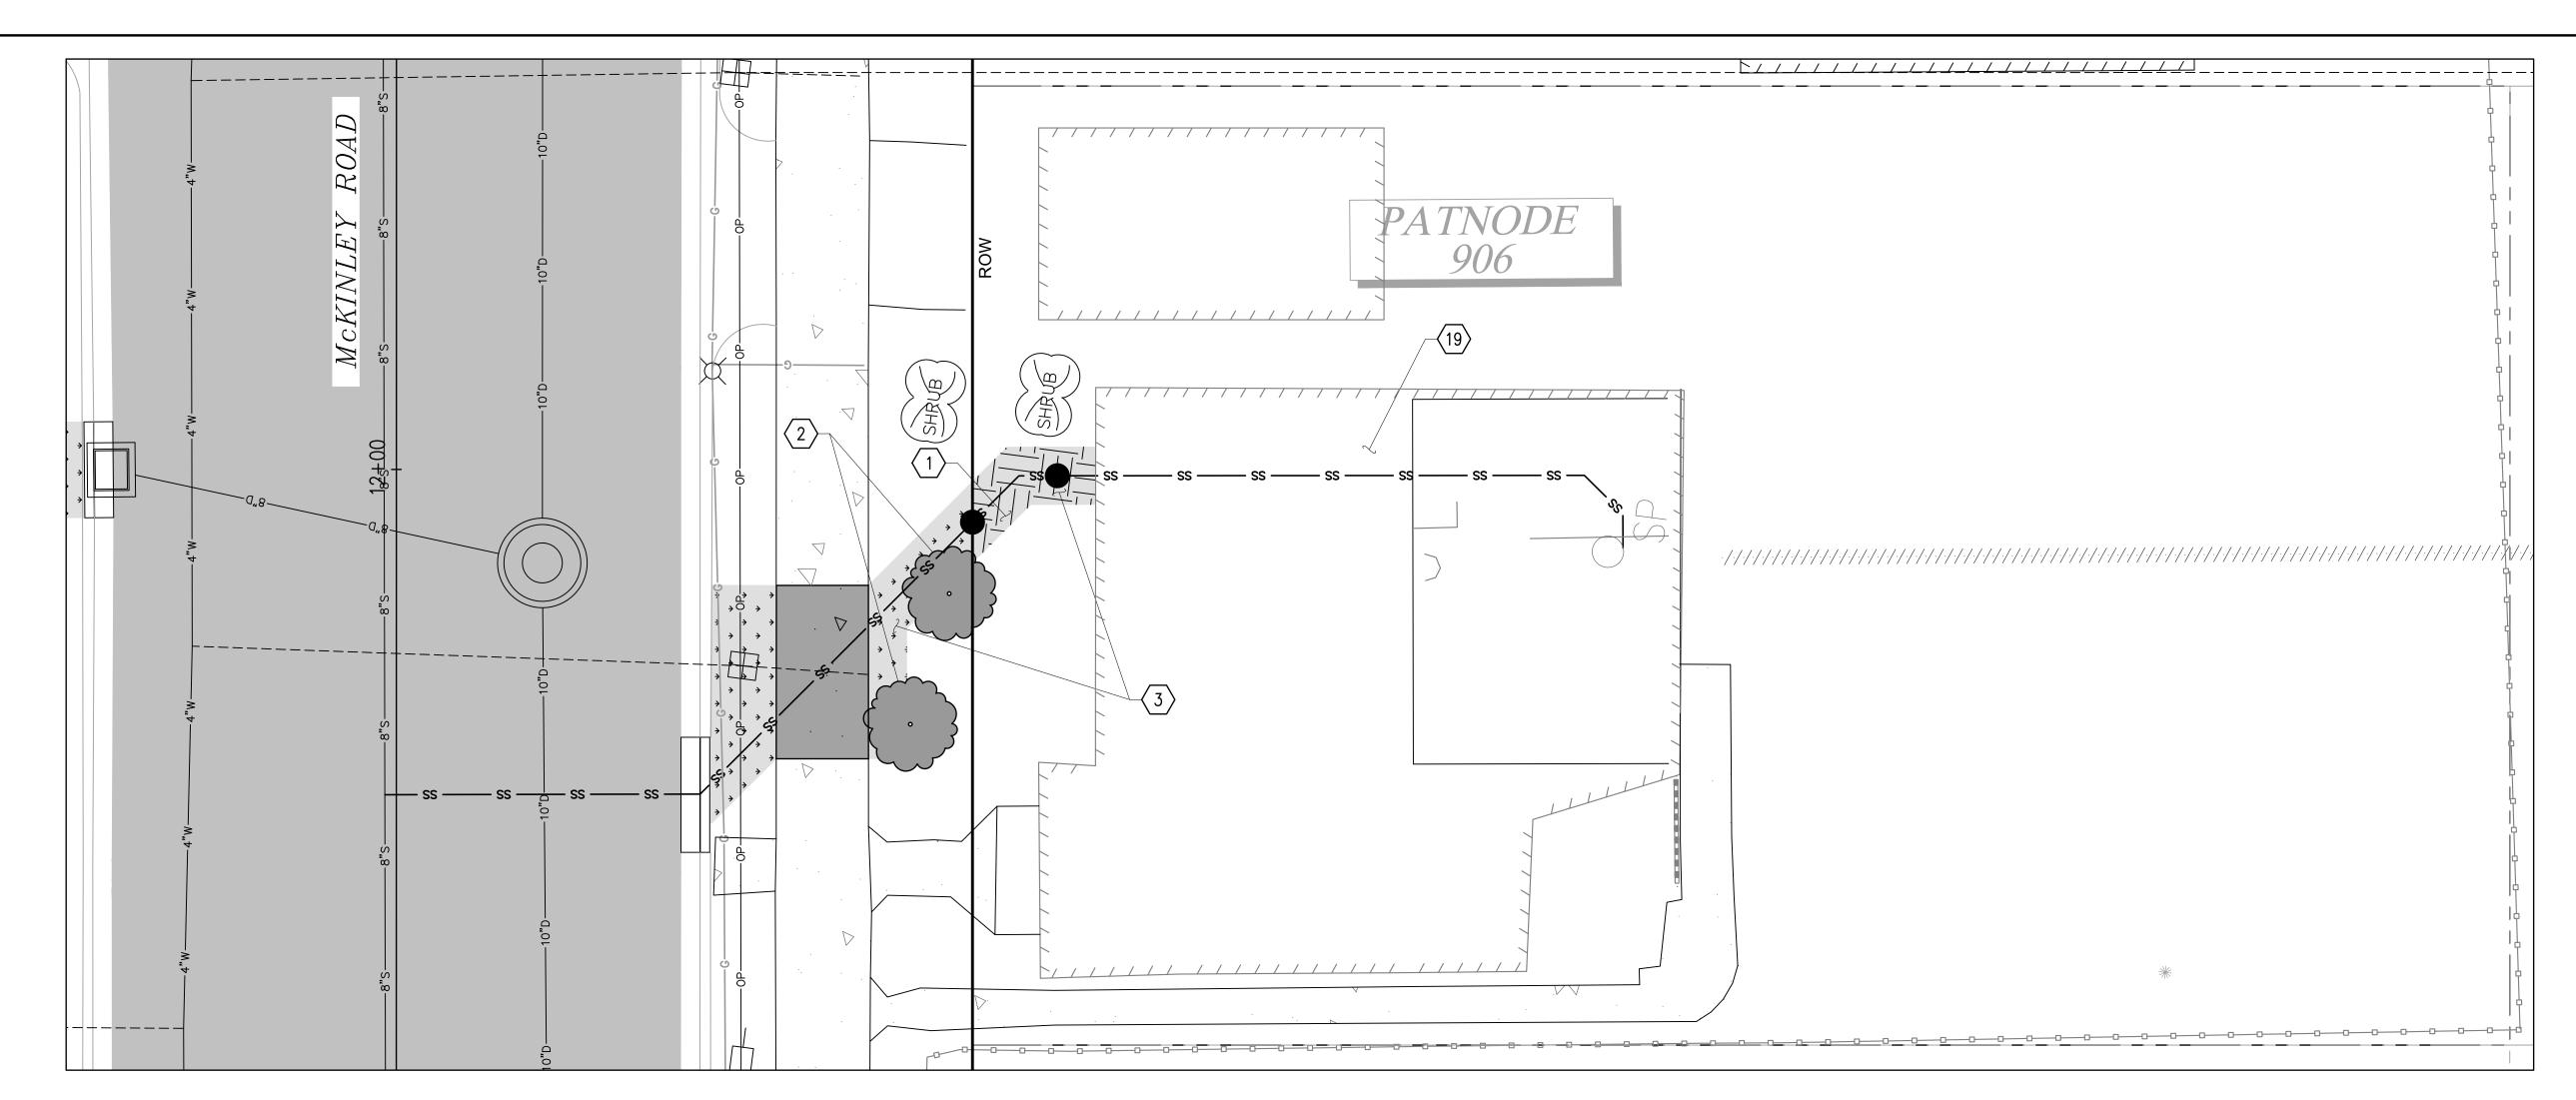

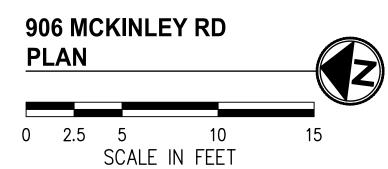

HARD SURFACE RESTORATION ON PRIVATE PROPERTY, SEE NOTES, THIS SHEET

SOFT SURFACE RESTORATION ON PRIVATE PROPERTY, SEE NOTES, THIS SHEET

PLANTER STRIP/LAWN WITHIN ROW

#### **GENERAL NOTES**

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- 2. FOR RESTORATION WITHIN ROW SEE SHEETS 29-31.

### **CONSTRUCTION NOTES**

- 1 RESTORE LAWN PER RESTORATION TABLE, SHEET 37.
- 2 REPLANT SALVAGED TREE/SHRUB OR REPLACE IN-KIND.
- 3 REINSTALL/REPLACE SALVAGED LAWN ORNAMENTS AND ART.
- RESTORE RESIDENCE TO PRECONSTRUCTION CONDITION. REMOVE ALL UNUSED CONSTRUCTION MATERIAL AND DEBRIS.


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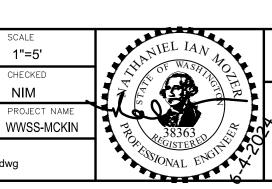
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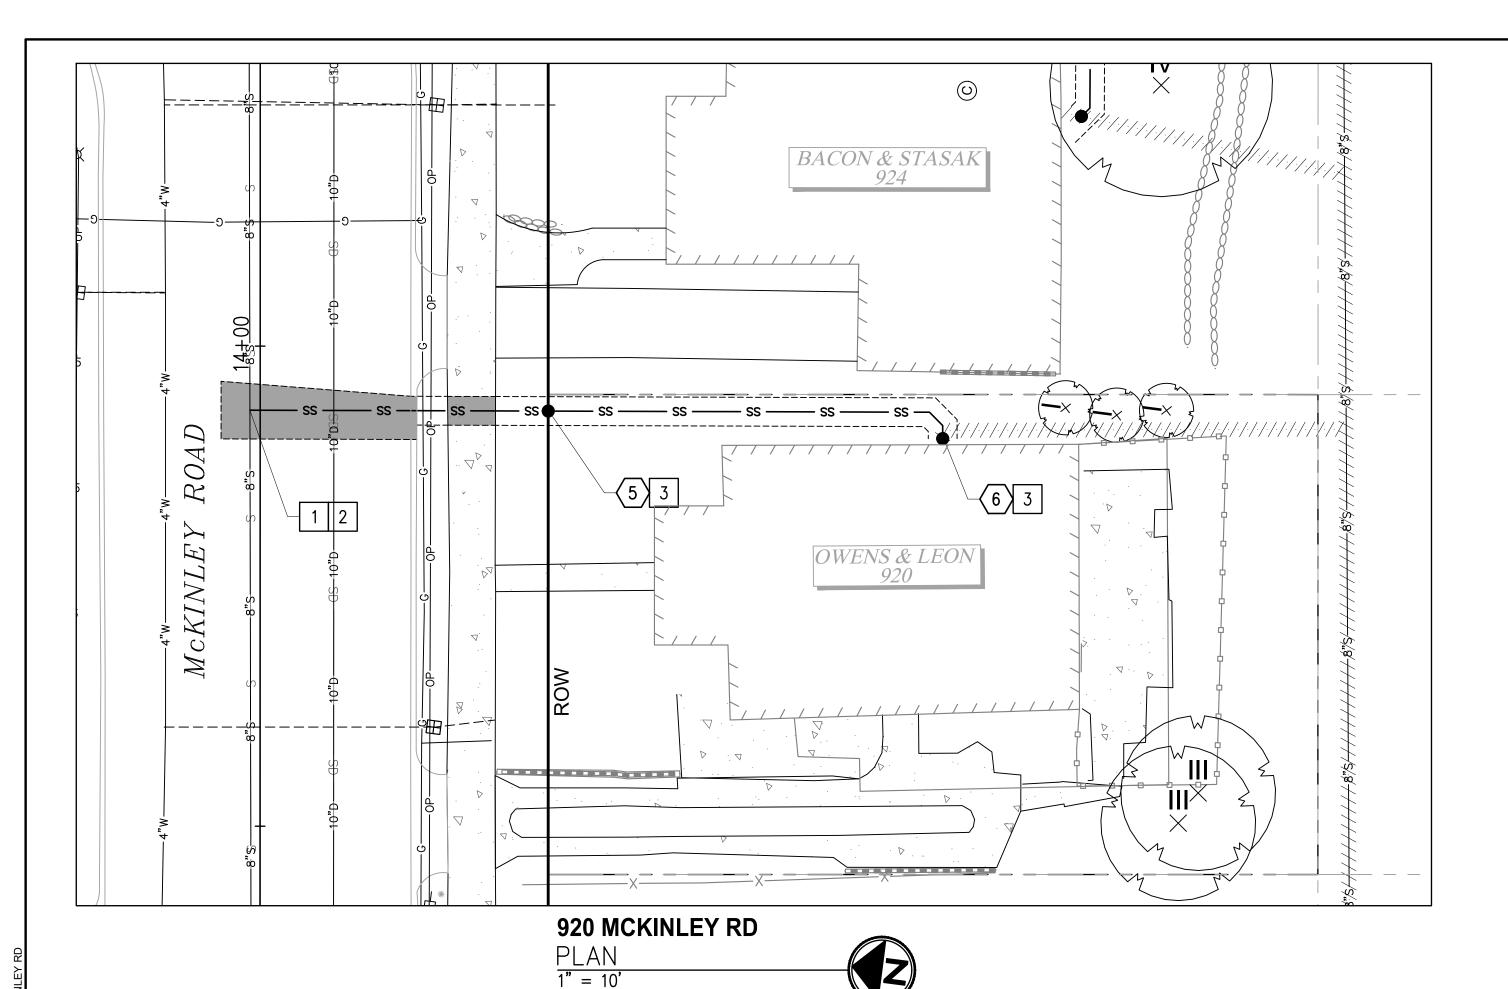
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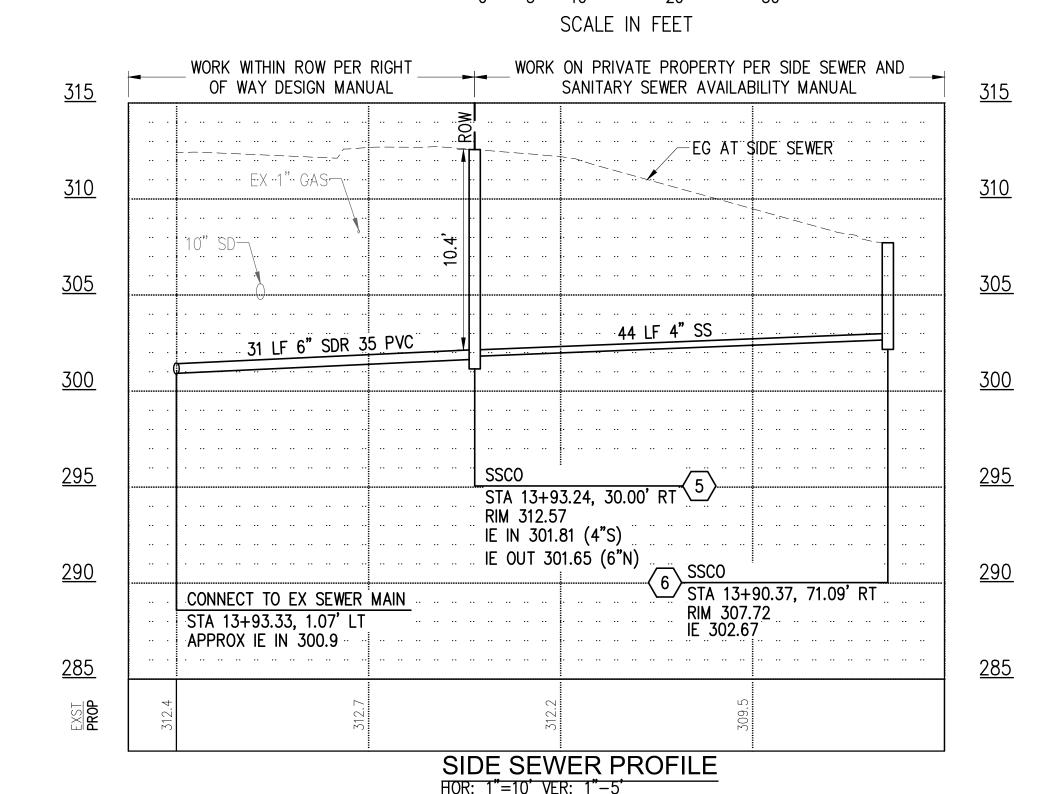


WASTEWATER SIDE SEWER IMPROVEMENTS MCKINLEY ROAD PRIVATE IMPROVEMENT RESTORATION PLAN 906 MCKINLEY ROAD

ENV-04018-08 PWK-00438-46

ES24-0034F



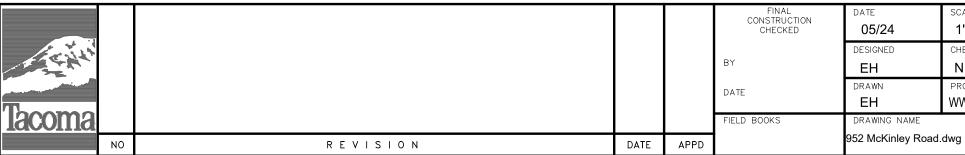



### CALL 2 DAYS **BEFORE YOU DIG** 1-800-424-5555

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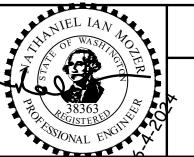






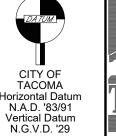

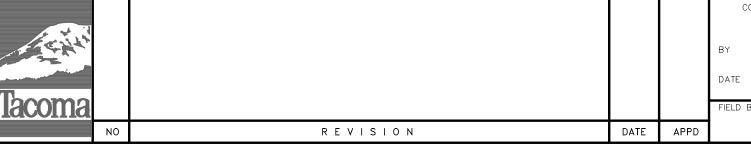CONSTRUCTION CHECKED 05/24 AS NOTED WWSS-MCKIN NV-04018-08-05 Side Sewers 01.c



**CONSTRUCTION NOTES** 

2, SHEET 37

SS CLEANOUT

4" ON PRIVATE PROPERTY.

—— ss —— SIDE SEWER

DETAIL 3, SHEET 37

SS CLEANOUT NUMBER

2. SIDE SEWER MINIMUM PIPE SLOPE IS 2.0%.

BUILDING DRAIN TO SIDE SEWER.

-EVERY CHANGE OF PIPE SIZE.

-EVERY 100' OF PIPE RUN.

-AT THE PROPERTY LINE.

**LEGEND** 

1 CONNECT TO EXISTING SEWER MAIN PER COT STANDARD PLAN SU-23.

2 CONSTRUCT PVC SIDE SEWER PER THE COT SIDE SEWER AND SANITARY SEWER AVAILABILITY MANUAL.

3 CONSTRUCT CLEANOUT PER COT STANDARD PLAN SU-24.

TEMPORARY HMA PATCH PER DETAIL

TEMPORARY CSTC TRENCH PATCH PER

SIDE SEWER CONSTRUCTION STANDARDS

1. PIPE SIZE SHALL BE A MINIMUM OF 6" WITHIN ROW AND MINIMUM OF

3. SIDE SEWERS SHALL HAVE A MINIMUM DEPTH OF 5' AT THE ROW

4. CLEANOUTS SHALL BE REQUIRED AT THE FOLLOWING LOCATIONS:

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### **GENERAL NOTES**


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CITY OF TACOMA ENVIRONMENTAL SERVICES DEPARTMENT

ES24-0034F

WASTEWATER SIDE SEWER IMPROVEMENTS MCKINLEY ROAD SIDE SEWER PLAN + PROFILE & TEMPORARY RESTORATION PLAN 920 MCKINLEY ROAD

ENV-04018-08 PWK-00438-46

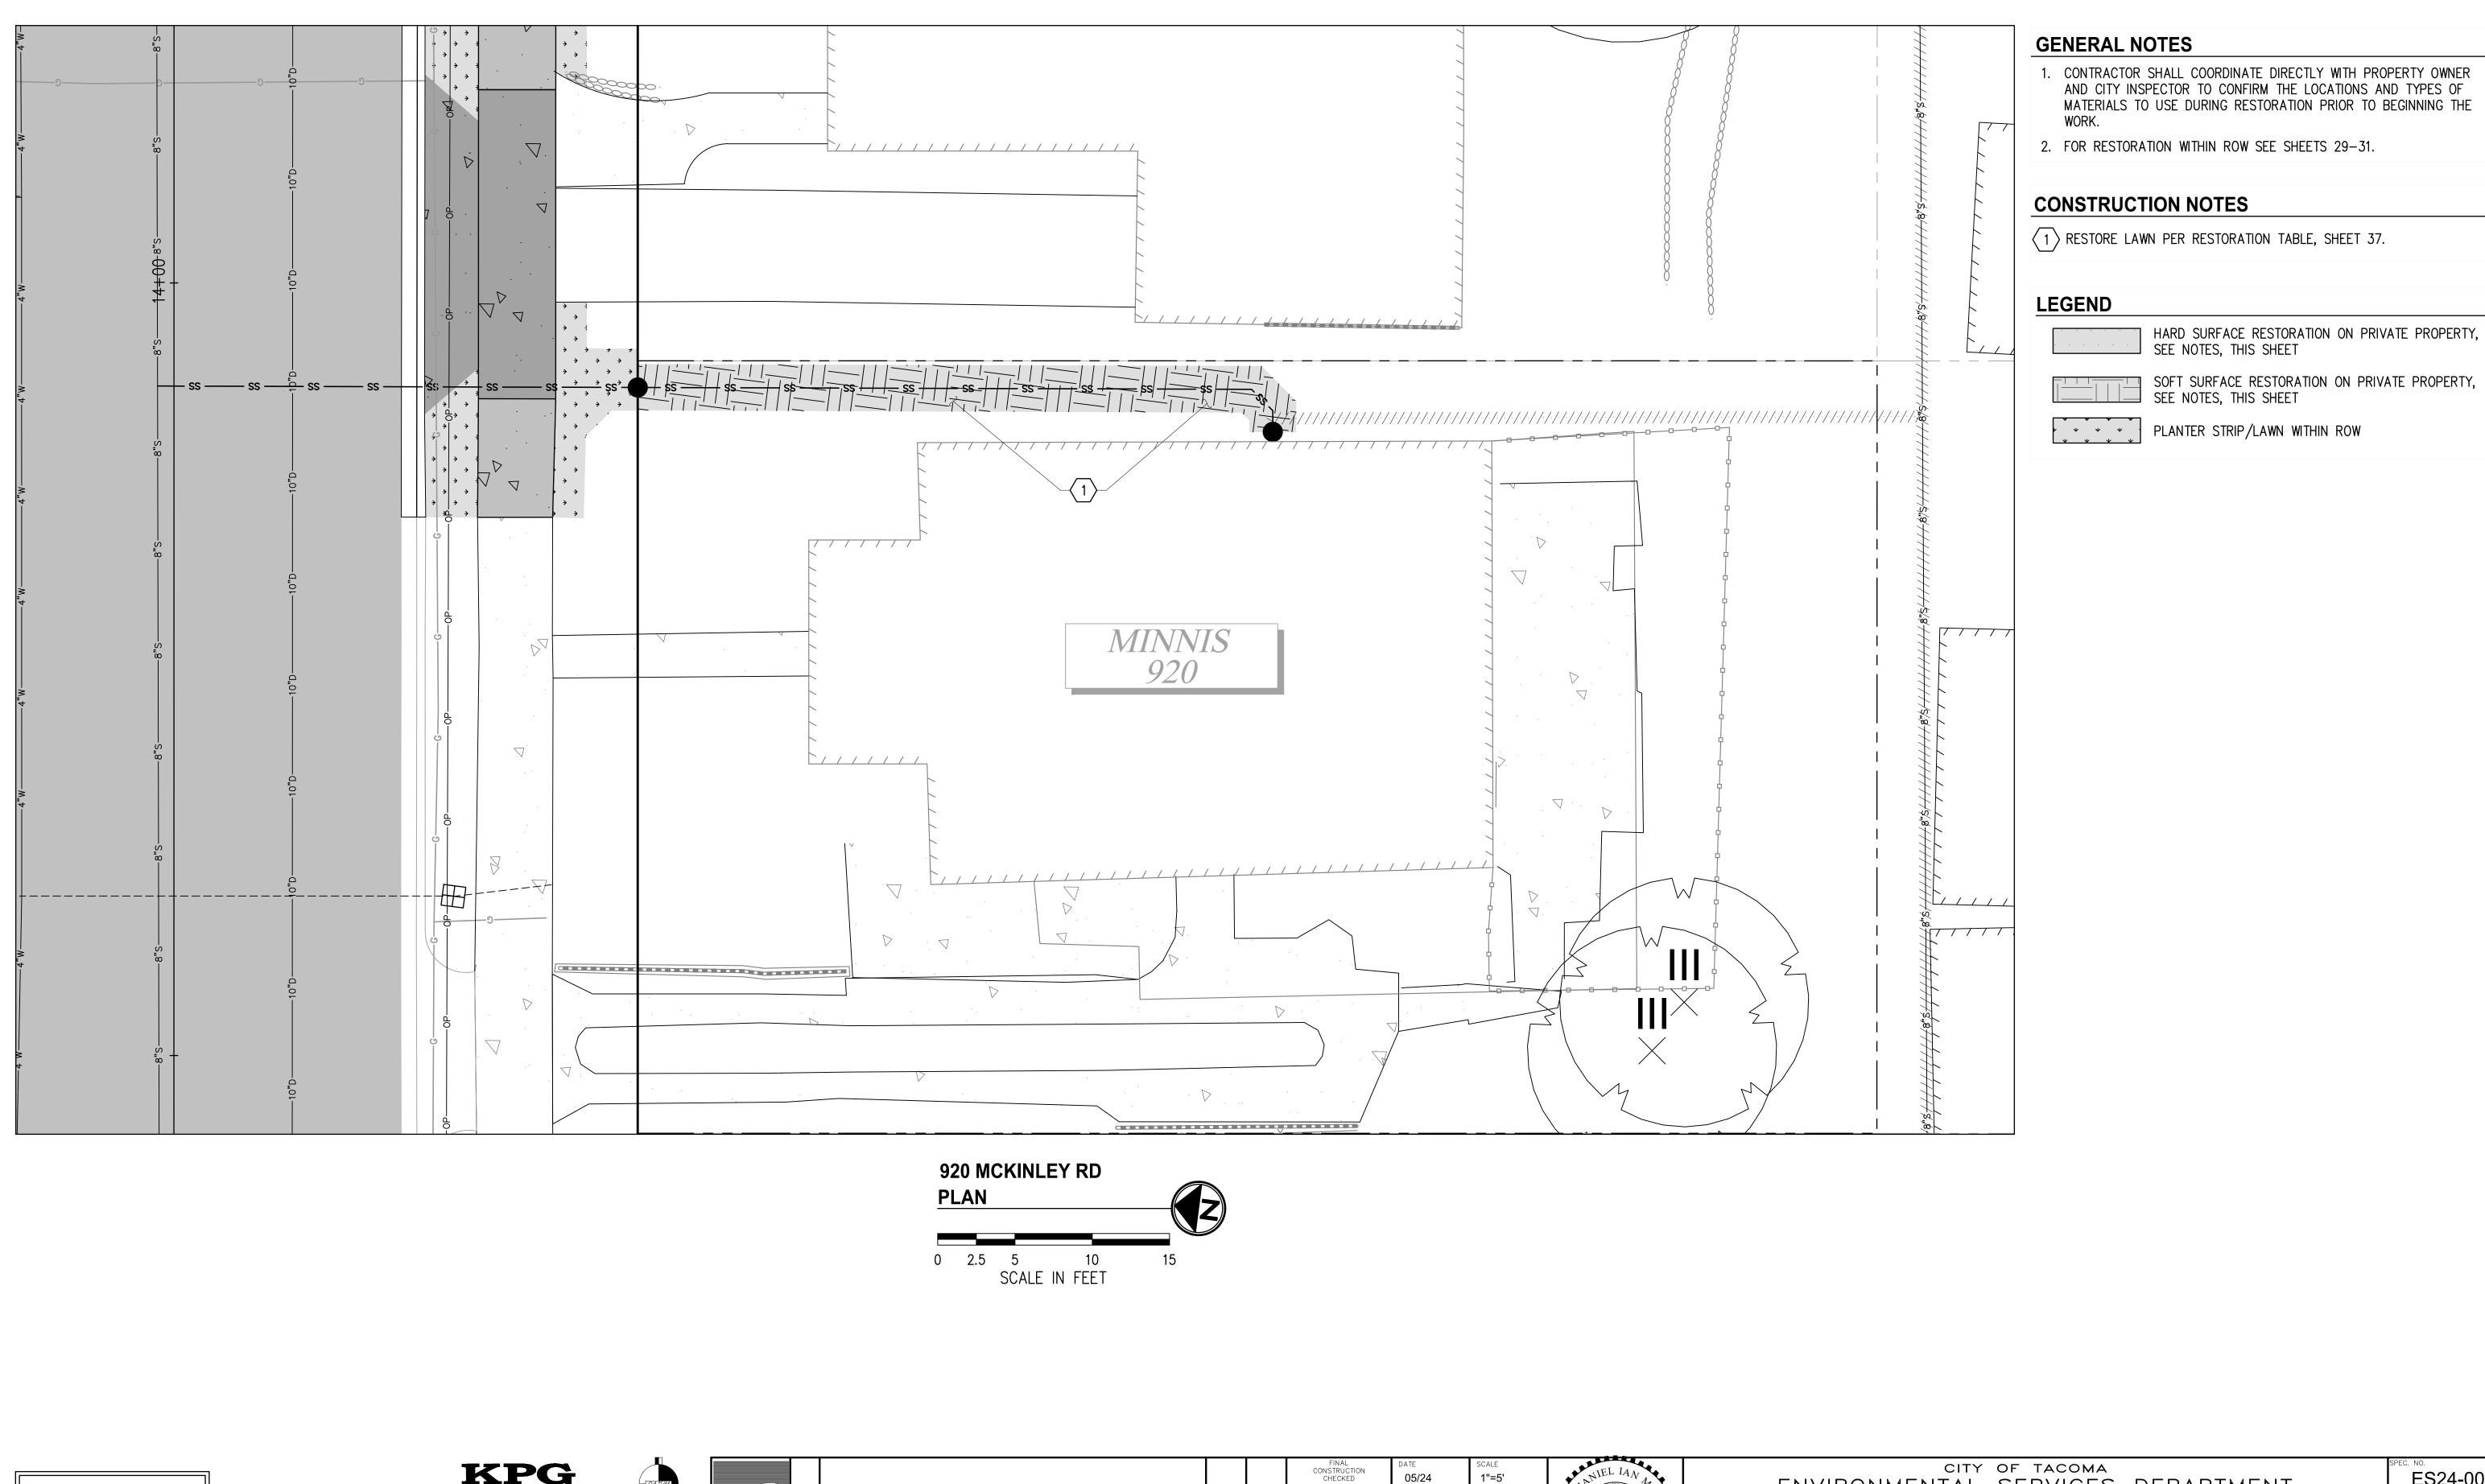


**CALL 2 DAYS BEFORE YOU DIG** 1-800-424-5555

BID **DOCUMENT** 

**KPG** P S O M A S Tacoma 2502 Jefferson Avenue Tacoma, WA 98402 253.627.0720 Seattle | Wenatchee | KPG.com

Horizontal Datum N.A.D. '83/91 Vertical Datum N.G.V.D. '29

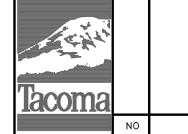

REVISION DATE APPD


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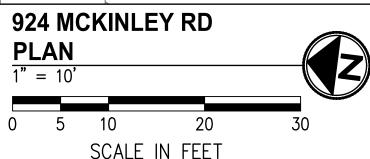
CITY OF TACOMA
ENVIRONMENTAL SERVICES DEPARTMENT


WASTEWATER SIDE SEWER IMPROVEMENTS MCKINLEY ROAD PRIVATE IMPROVEMENT RESTORATION PLAN 920 MCKINLEY ROAD

ENV-04018-08 PWK-00438-46

ES24-0034F



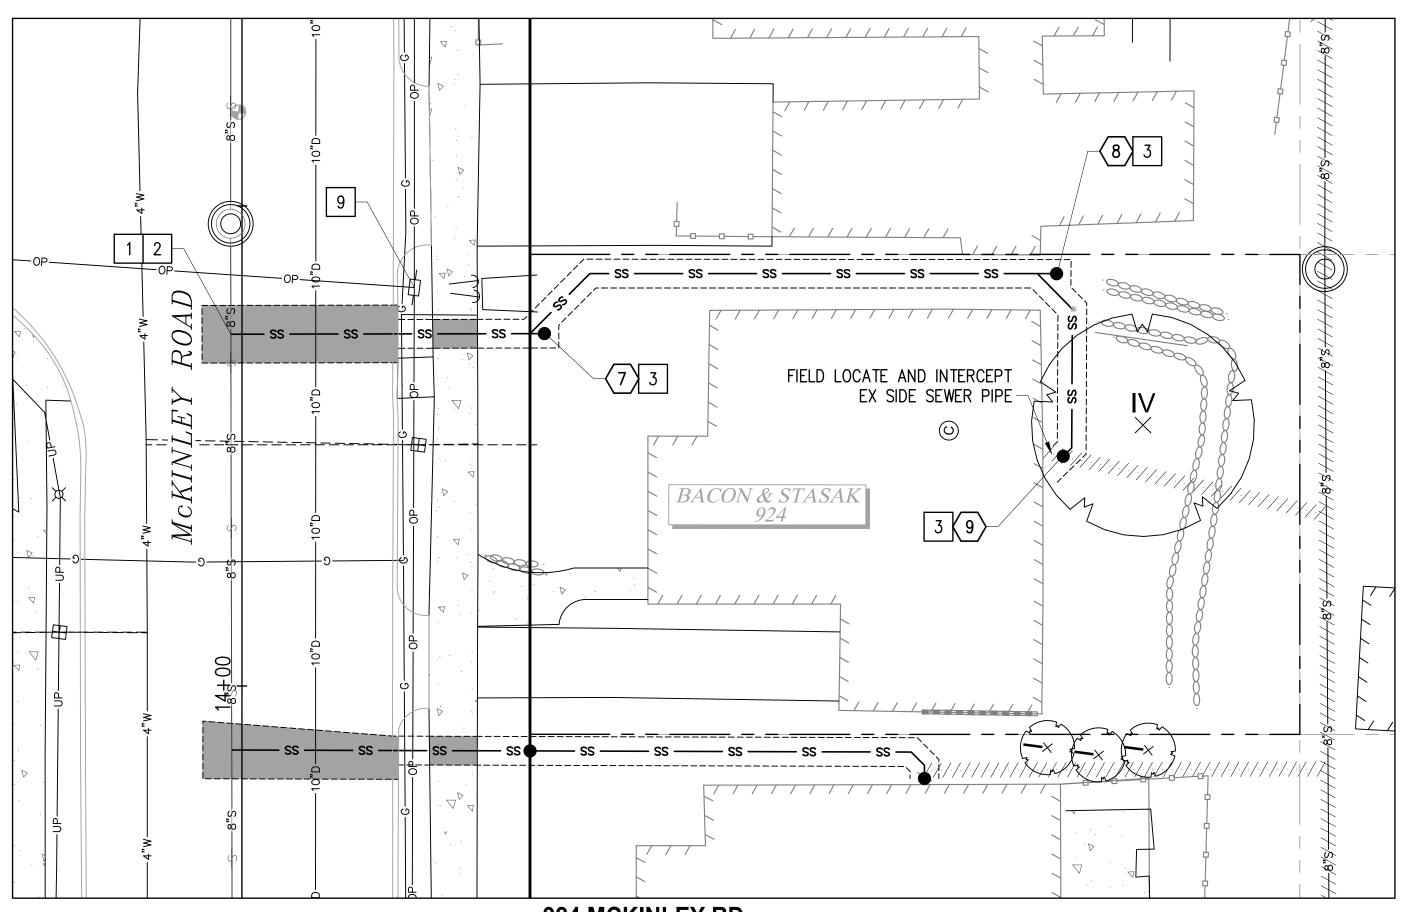

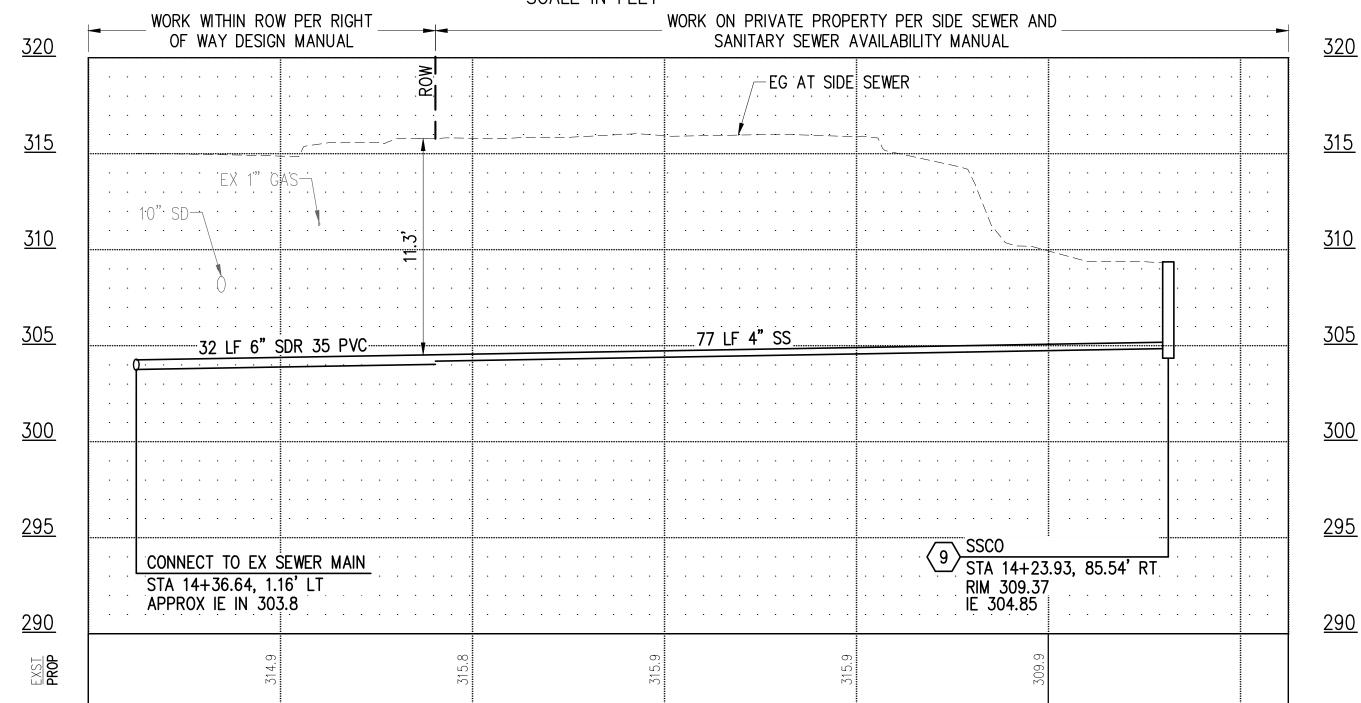

#### SIDE SEWER PROFILE HOR: 1"=10' VER: 1"-5'

CALL 2 DAYS **BEFORE YOU DIG** 1-800-424-5555

BID **DOCUMENT** 











CONSTRUCTION CHECKED 05/24 AS NOTED **WWSS-MCKIN** :NV-04018-08-05 PS Side Sewers 0

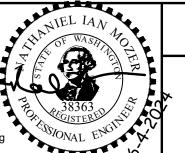

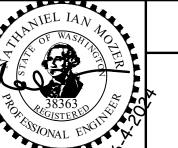

**CONSTRUCTION NOTES** 

PROVISION 1-07.17).

— ss — SIDE SEWER

2, SHEET 37

SS CLEANOUT

4" ON PRIVATE PROPERTY.

DETAIL 3, SHEET 37

SS CLEANOUT NUMBER

2. SIDE SEWER MINIMUM PIPE SLOPE IS 2.0%.

BUILDING DRAIN TO SIDE SEWER.

-EVERY CHANGE OF PIPE SIZE.

-EVERY 100' OF PIPE RUN.

-AT THE PROPERTY LINE.

**LEGEND** 

1 CONNECT TO EXISTING SEWER MAIN PER COT STANDARD PLAN SU-23.

2 CONSTRUCT PVC SIDE SEWER PER THE COT SIDE SEWER AND SANITARY SEWER AVAILABILITY MANUAL.

9 LUMINAIRE/UTILITY POLE - COORDINATE WITH TPU (SEE SPECIAL

3 CONSTRUCT CLEANOUT PER COT STANDARD PLAN SU-24.

TEMPORARY HMA PATCH PER DETAIL

TEMPORARY CSTC TRENCH PATCH PER

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1. PIPE SIZE SHALL BE A MINIMUM OF 6" WITHIN ROW AND MINIMUM OF

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- 4. SIDE SEWERS WITHIN 10' HORIZONTALLY OR 18" VERTICALLY OF EXISTING WATER SERVICE SHALL BE CONSTRUCTED WITH C900 PVC SEWER PIPE.
- 5. THE EXISTING SIDE SEWER PIPE MATERIAL(S) IS UNKNOWN. CONTRACTOR SHALL BE RESPONSIBLE FOR DETERMINING EXISTING PIPE MATERIALS AND PROVIDING AN APPROPRIATE COUPLING TO TRANSITION FROM EXISTING TO PROPOSED SIDE SEWER PIPE
- 6. CONSTRUCTION MAY REQUIRE EXCAVATION WITHIN 10 FEET OF UTILITY POLES. WHERE ANTICIPATED, CONTRACTOR SHALL CONTACT TACOMA POWER (253) 502-8991 AT LEAST 2 WEEKS IN ADVANCE OF ANY CONSTRUCTION ACTIVITY WITHIN 10 FEET OF AN EXISTING POLE TO COORDINATE AN ONSITE VISIT WITH A TPU FIELD INSPECTOR. SEE SPECIAL PROVISION SECTION 1-07.17 FOR ADDITIONAL DETAIL AND REQUIREMENTS.
- 7. CONSTRUCTION WILL REQUIRE EXCAVATION IMMEDIATELY ADJACENT TO EXISTING BUILDING AND STRUCTURES, THE MAJORITY OF WHICH WERE CONSTRUCTED IN THE 1920'S. IT IS THE CONTRACTOR'S RESPONSIBILITY TO PRESERVE AND PROTECT ALL BUILDINGS AND STRUCTURES AND TO MAKE SURE CONSTRUCTION METHODS, SHORING METHODS, AND COMPACTION METHODS ARE APPROPRIATE GIVEN THE LOCATION OF THE CONSTRUCTION AREA.
- 8. CONTRACTOR SHALL BE RESPONSIBLE FOR LOCATING EXISTING UTILITIES ON PRIVATE PROPERTY.


CITY OF TACOMA ENVIRONMENTAL SERVICES DEPARTMENT


WASTEWATER SIDE SEWER IMPROVEMENTS MCKINLEY ROAD SIDE SEWER PLAN + PROFILE & TEMPORARY RESTORATION PLAN 924 MCKINLEY ROAD

ENV-04018-08 PWK-00438-46

13 <sub>OF</sub> 37

ES24-0034F

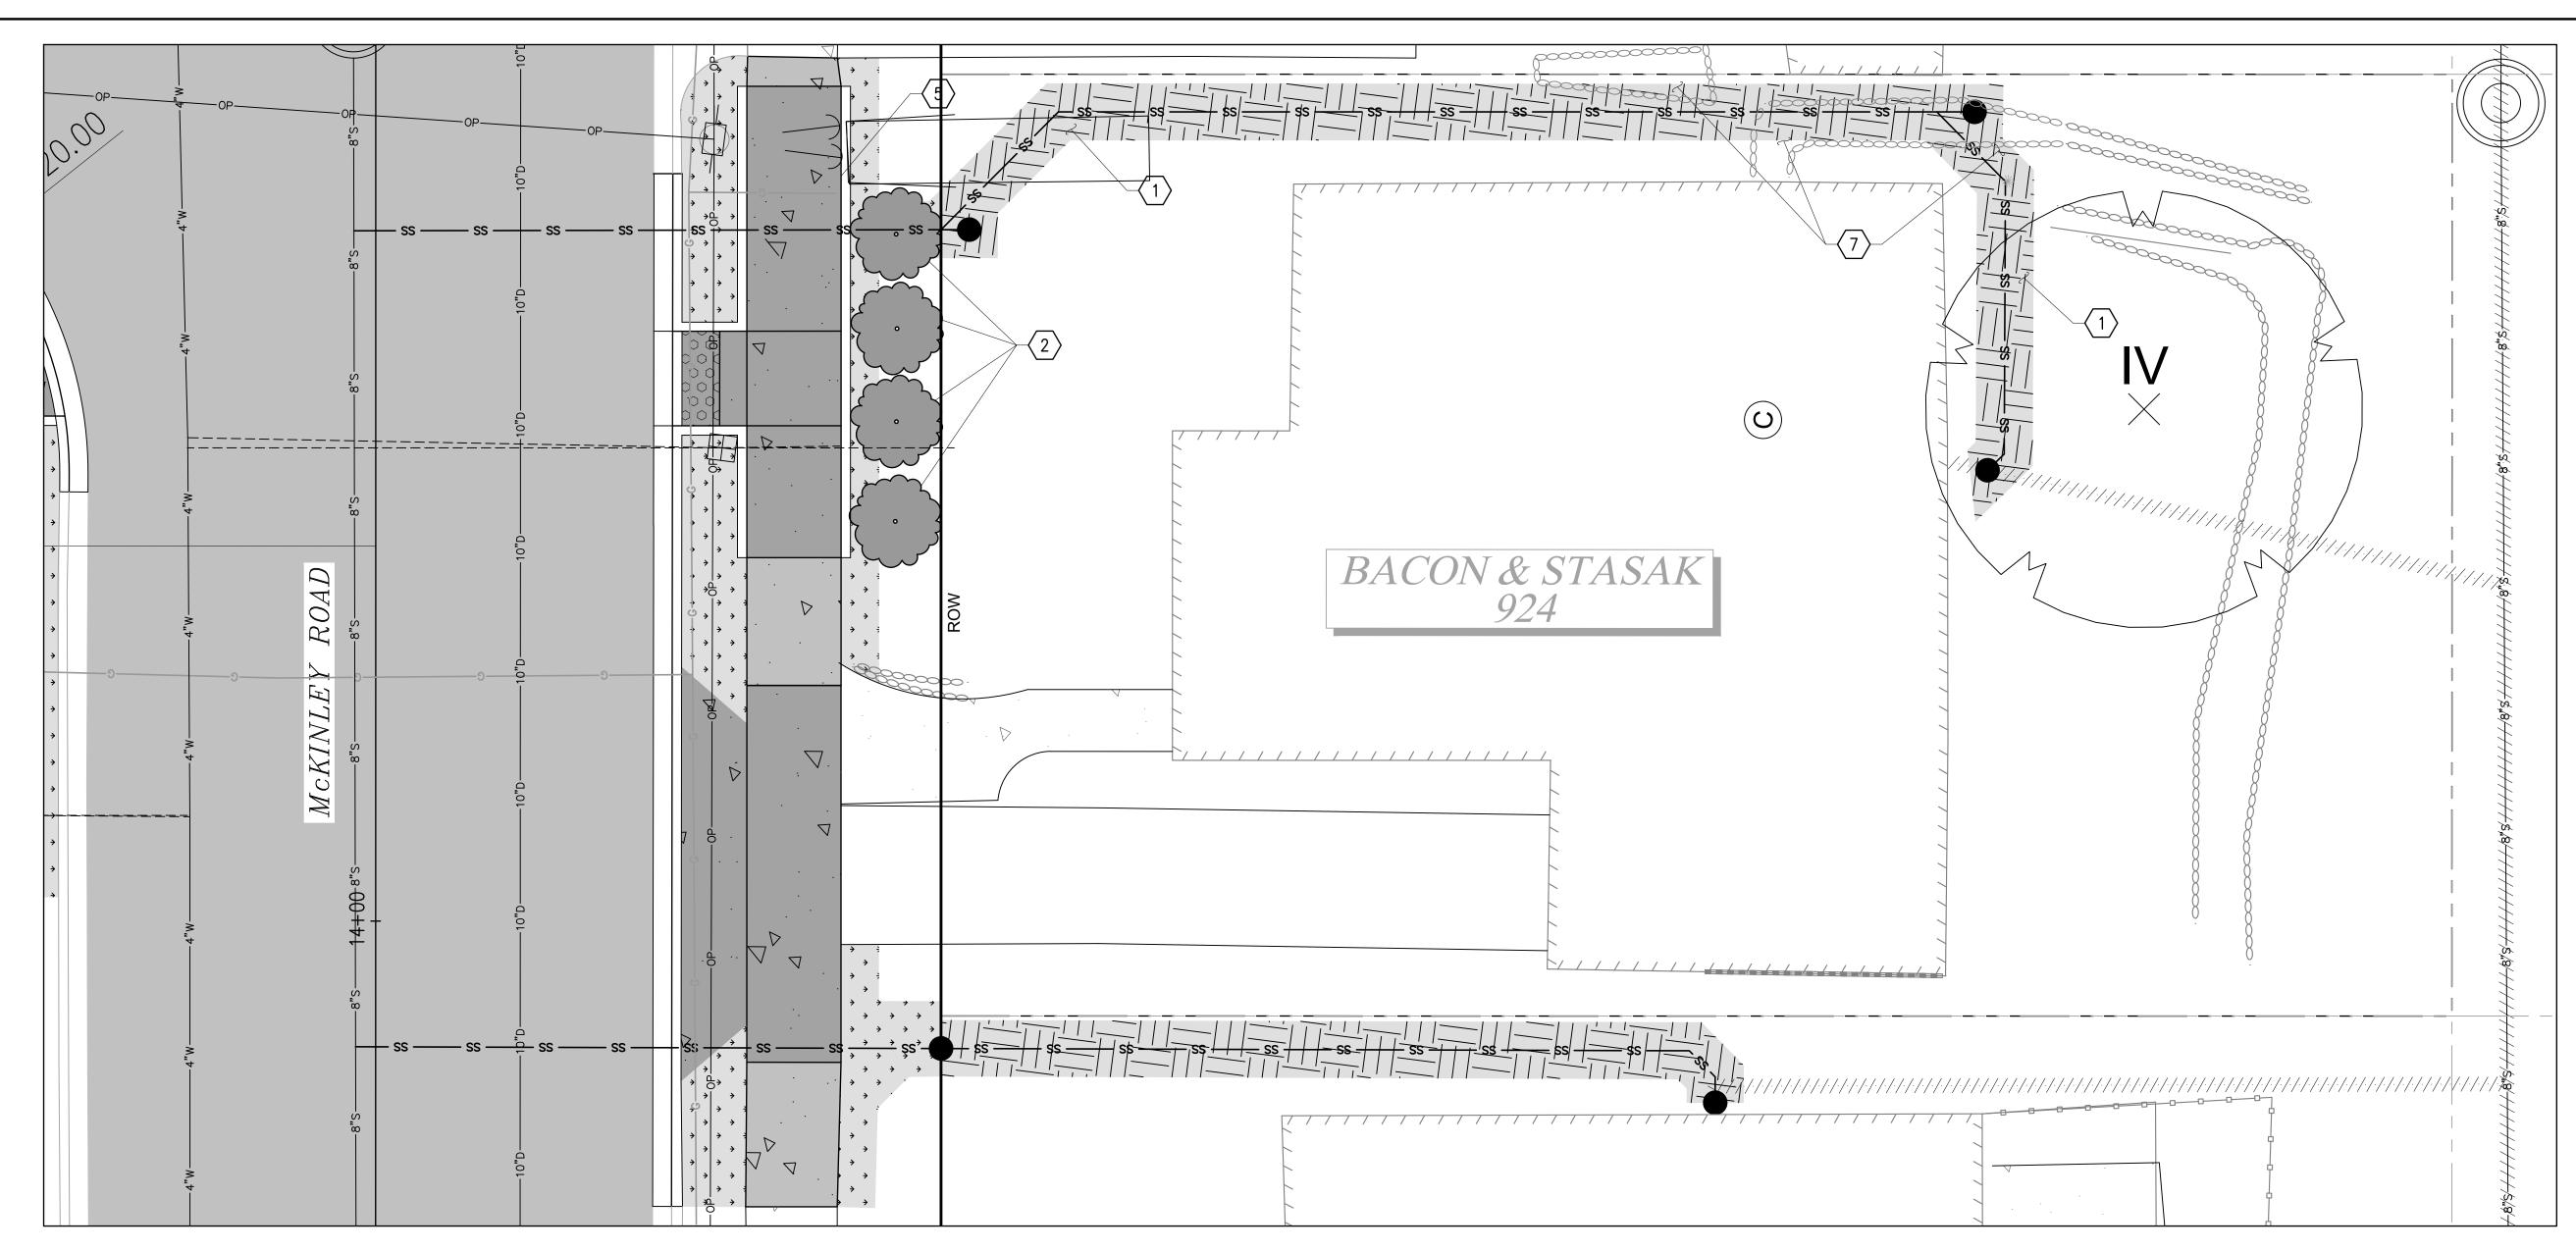

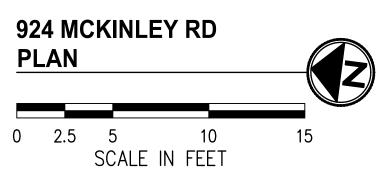

HARD SURFACE RESTORATION ON PRIVATE PROPERTY, SEE NOTES, THIS SHEET

SOFT SURFACE RESTORATION ON PRIVATE PROPERTY, SEE NOTES, THIS SHEET

PLANTER STRIP/LAWN WITHIN ROW

### **GENERAL NOTES**

- . CONTRACTOR SHALL COORDINATE DIRECTLY WITH PROPERTY OWNER AND CITY INSPECTOR TO CONFIRM THE LOCATIONS AND TYPES OF MATERIALS TO USE DURING RESTORATION PRIOR TO BEGINNING THE WORK.
- 2. FOR RESTORATION WITHIN ROW SEE SHEETS 29-31.

#### **CONSTRUCTION NOTES**

- 1 RESTORE LAWN PER RESTORATION TABLE, SHEET 37.
- 2 REPLANT SALVAGED TREE/SHRUB OR REPLACE IN-KIND.
- REINSTALL SALVAGED LANDSCAPE BORDER AT PRECONSTRUCTION LOCATION AND CONDITION OR REPLACE IN-KIND.
- 7 REINSTALL SALVAGED ROCKERY AT PRECONSTRUCTION LOCATION AND CONDITION OR REPLACE IN-KIND.

**CALL 2 DAYS BEFORE YOU DIG** 1-800-424-5555

BID **DOCUMENT** 




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					FINAL CONSTRUCTION CHECKED	05/24	SCALE 1"=5'
E.H.					BY DATE	DESIGNED  EH  DRAWN	CHECKED  NIM  PROJECT NAM
coma					FIELD BOOKS	EH DRAWING NAME	WWSS-MCKI
	NO	REVISION	DATE	APPD		952 McKinley Road.	dwg




ENVIRONMENTAL SERVICES DEPARTMENT


WASTEWATER SIDE SEWER IMPROVEMENTS MCKINLEY ROAD PRIVATE IMPROVEMENT RESTORATION PLAN 924 MCKINLEY ROAD

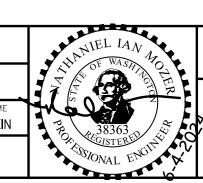CITY OF TACOMA

ENV-04018-08 PWK-00438-46

ES24-0034F

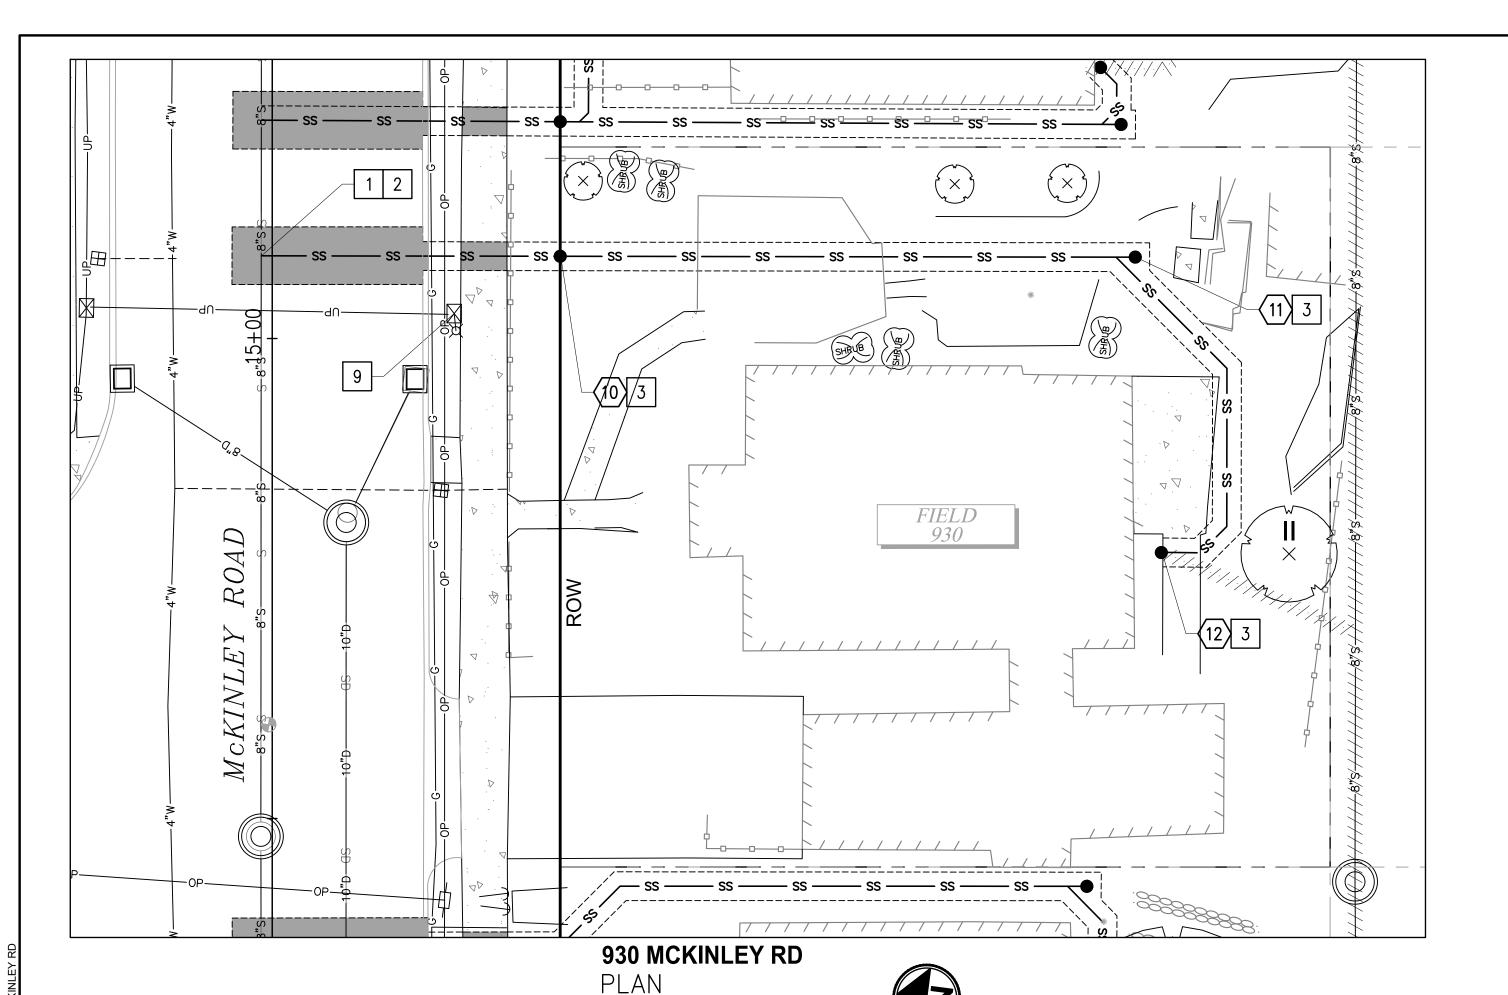

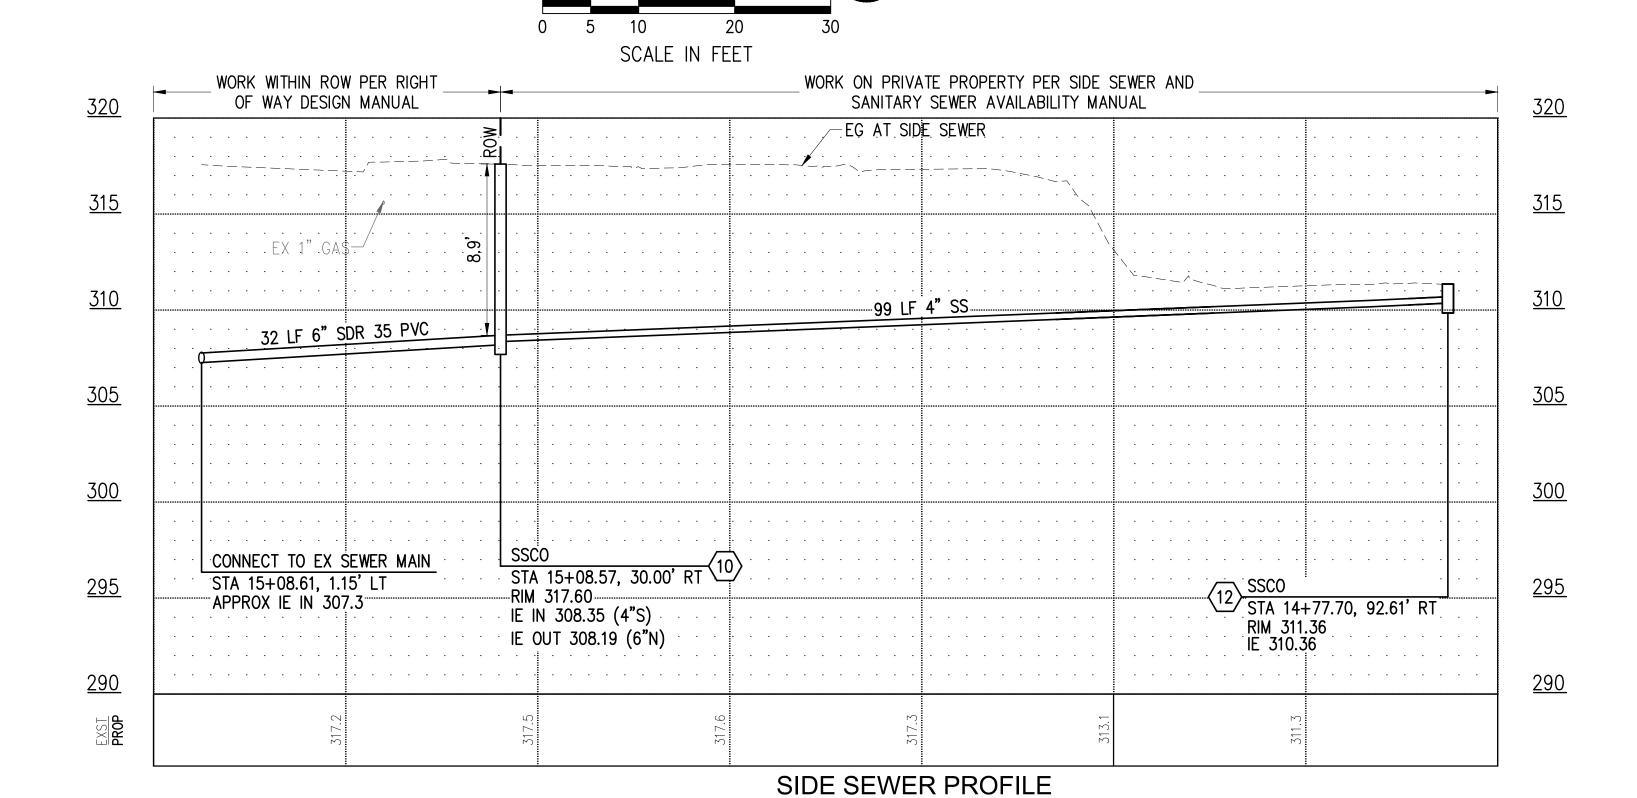

- 1 CONNECT TO EXISTING SEWER MAIN PER COT STANDARD PLAN SU-23.
- 2 CONSTRUCT PVC SIDE SEWER PER THE COT SIDE SEWER AND SANITARY SEWER AVAILABILITY MANUAL.
- 3 CONSTRUCT CLEANOUT PER COT STANDARD PLAN SU-24.
- 9 LUMINAIRE/UTILITY POLE COORDINATE WITH TPU (SEE SPECIAL PROVISION 1-07.17).

#### **LEGEND**



TEMPORARY HMA PATCH PER DETAIL 2. SHEET 37



TEMPORARY CSTC TRENCH PATCH PER DETAIL 3, SHEET 37

— ss — SIDE SEWER

SS CLEANOUT



SS CLEANOUT NUMBER

#### SIDE SEWER CONSTRUCTION STANDARDS

- 1. PIPE SIZE SHALL BE A MINIMUM OF 6" WITHIN ROW AND MINIMUM OF 4" ON PRIVATE PROPERTY.
- 2. SIDE SEWER MINIMUM PIPE SLOPE IS 2.0%.
- 3. SIDE SEWERS SHALL HAVE A MINIMUM DEPTH OF 5' AT THE ROW
- 4. CLEANOUTS SHALL BE REQUIRED AT THE FOLLOWING LOCATIONS: -APPROXIMATELY 2' FROM THE BUILDING AT THE CHANGE FROM BUILDING DRAIN TO SIDE SEWER.
- -EVERY 135 DEGREES OF TOTAL BEND (INCLUDING HORZ. AND VERT.). -EVERY 100' OF PIPE RUN.
- -EVERY CHANGE OF PIPE SIZE.
- -AT THE PROPERTY LINE.
- 5. PIPE SHALL HAVE MINIMUM DEPTH OF COVER OF 3' IN DRIVING AREAS.

#### **GENERAL NOTES**

- 1. THE HORIZONTAL AND VERTICAL SIDE SEWER CONFIGURATION SHOWN ON THIS SHEET IS APPROXIMATE BASED ON THE INFORMATION AVAILABLE DURING DESIGN. THE CONTRACTOR MAY, WITH THE APPROVAL OF THE CONSTRUCTION INSPECTOR, ADJUST THE SIDE SEWER ALIGNMENT AS NEEDED TO BETTER ACCOMMODATE CONSTRUCTION METHODS AND CONDITIONS EXPERIENCED DURING CONSTRUCTION.
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- 8. CONTRACTOR SHALL BE RESPONSIBLE FOR LOCATING EXISTING UTILITIES ON PRIVATE PROPERTY.

CALL 2 DAYS **BEFORE YOU DIG** 1-800-424-5555

BID **DOCUMENT** 











HOR: 1"=10' VER: 1"-5'

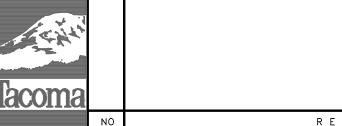

CONSTRUCTION CHECKED 05/24 AS NOTED **WWSS-MCKIN** NV-04018-08-05 Side Sewers 01.c REVISION DATE

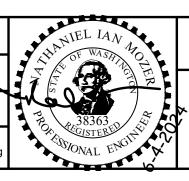




WASTEWATER SIDE SEWER IMPROVEMENTS MCKINLEY ROAD SIDE SEWER PLAN + PROFILE & TEMPORARY RESTORATION PLAN 930 MCKINLEY ROAD

ES24-0034F ENV-04018-08

PWK-00438-46

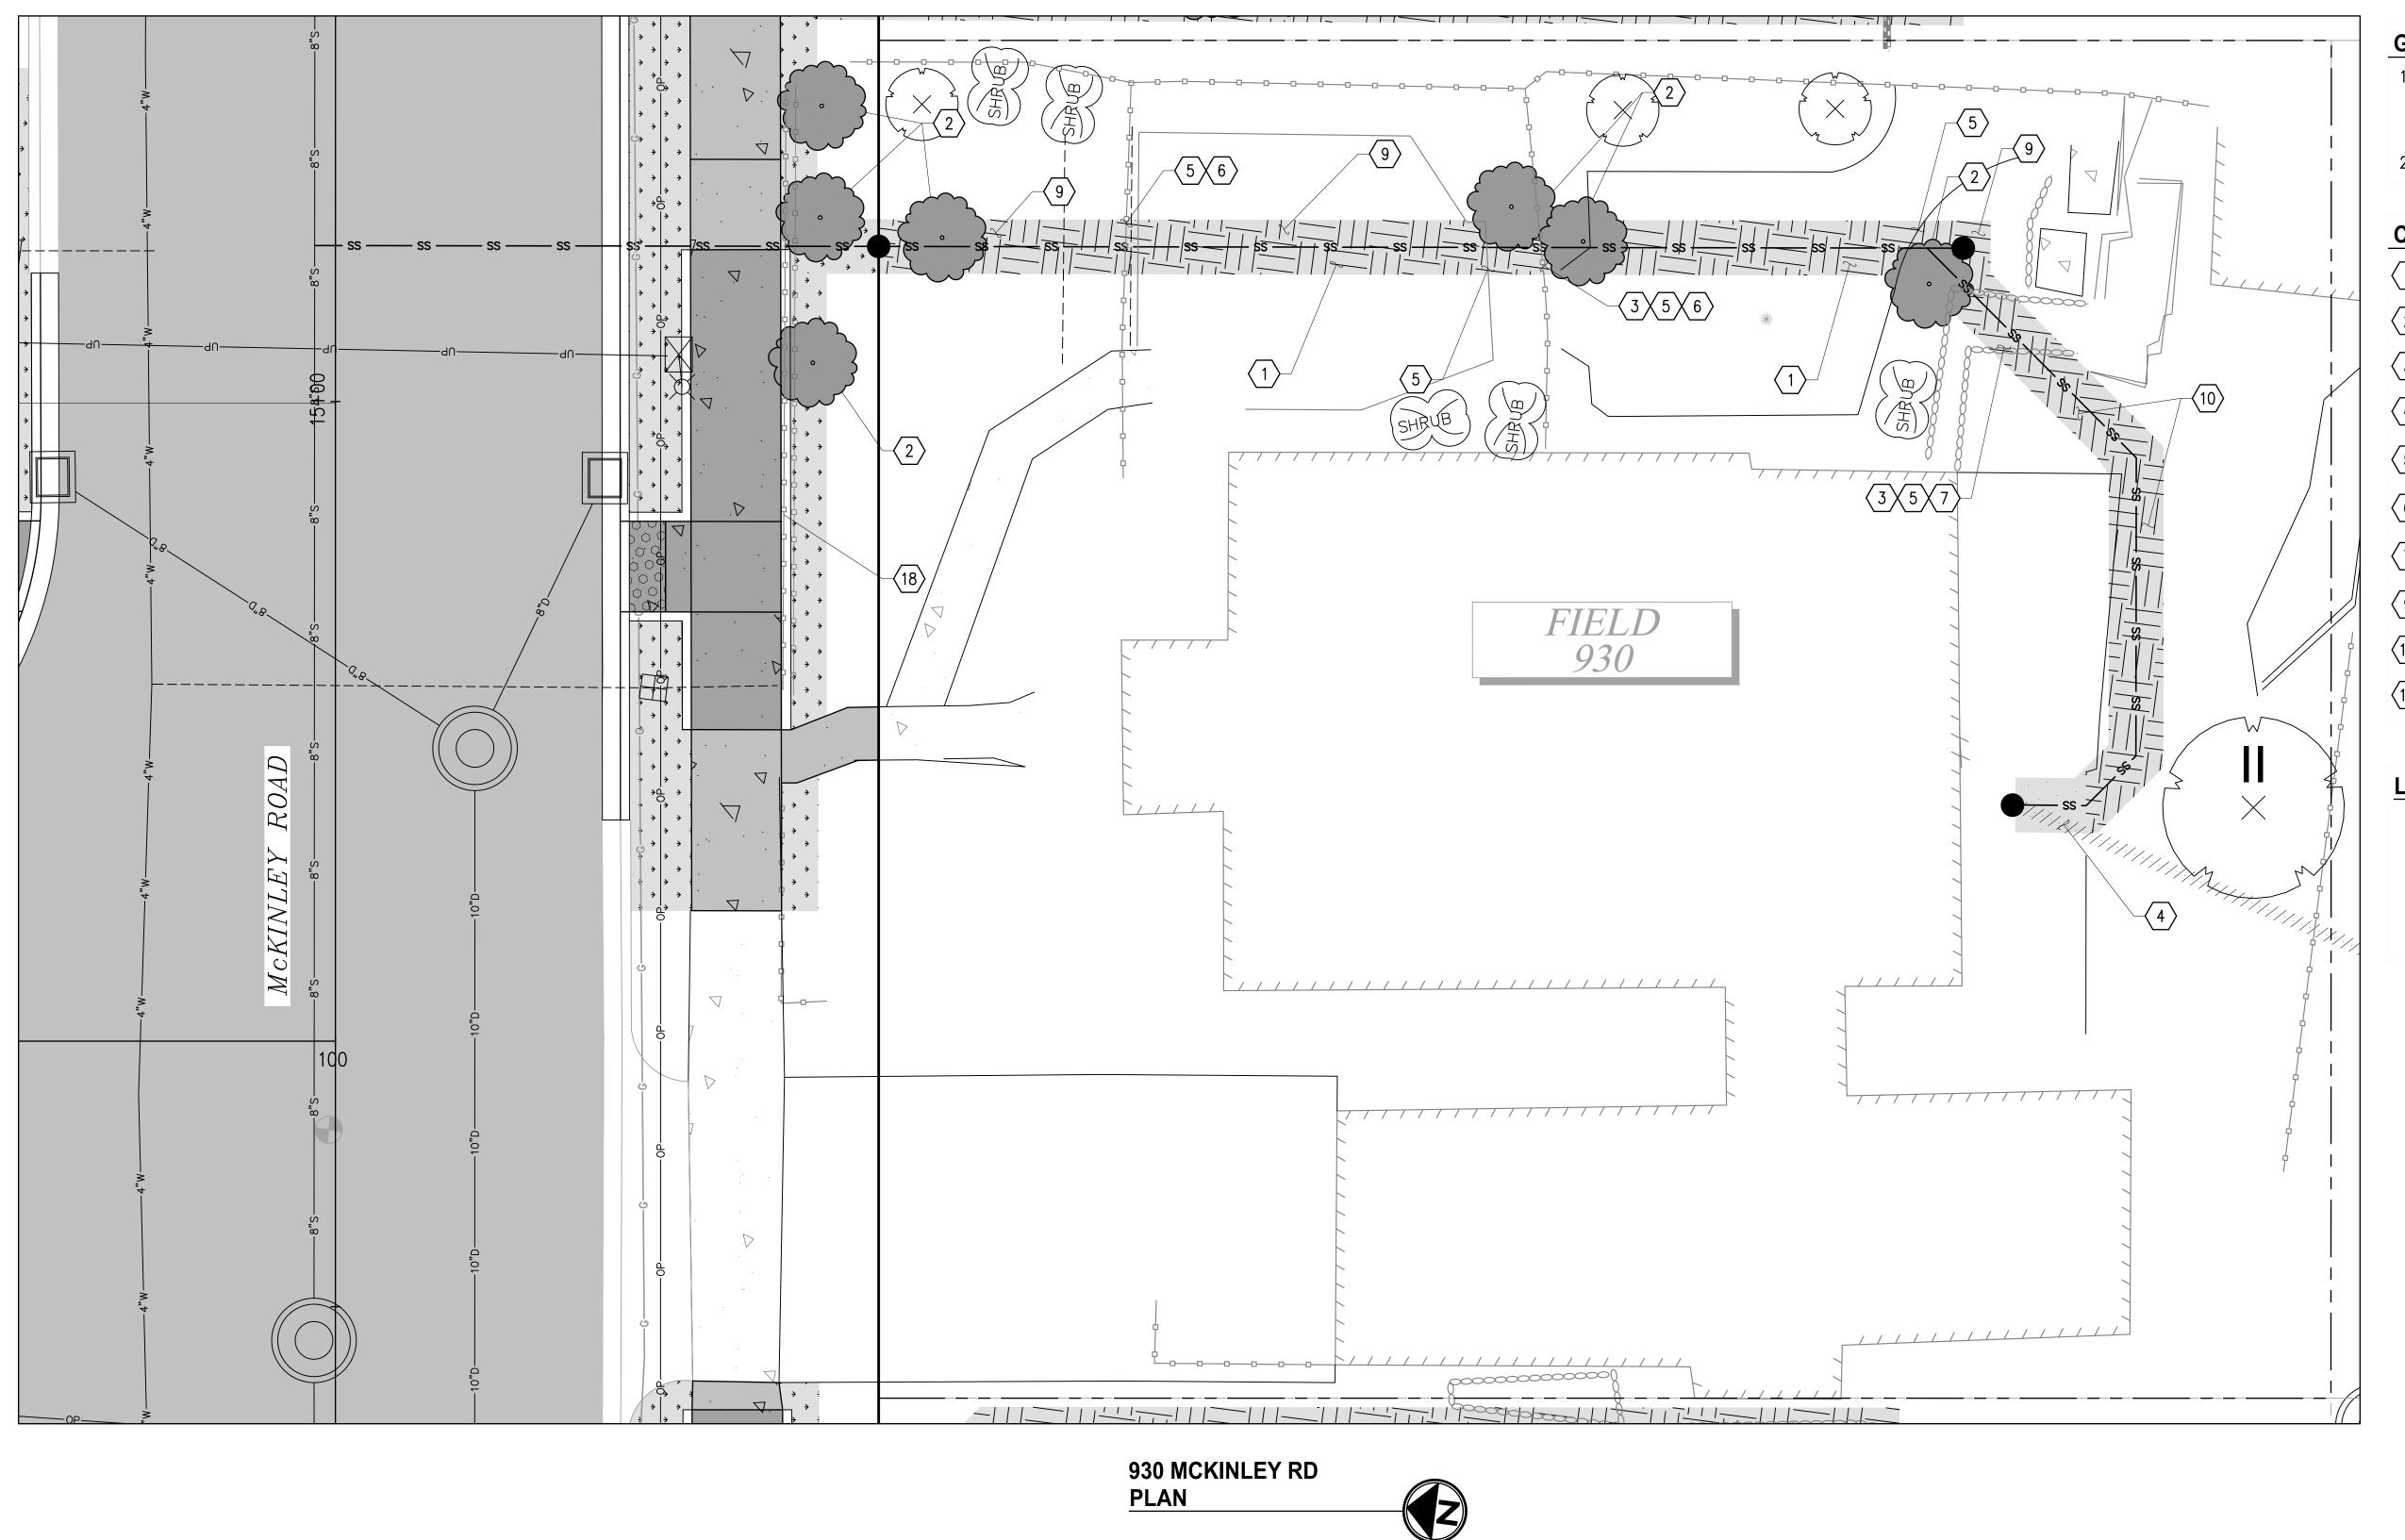

- 1. CONTRACTOR SHALL COORDINATE DIRECTLY WITH PROPERTY OWNER AND CITY INSPECTOR TO CONFIRM THE LOCATIONS AND TYPES OF MATERIALS TO USE DURING RESTORATION PRIOR TO BEGINNING THE
- 2. FOR RESTORATION WITHIN ROW SEE SHEETS 29-31.

#### **CONSTRUCTION NOTES**

- 1 RESTORE LAWN PER RESTORATION TABLE, SHEET 37.
- 2 REPLANT SALVAGED TREE/SHRUB OR REPLACE IN-KIND.
- (3) REINSTALL/REPLACE SALVAGED LAWN ORNAMENTS AND ART.
- REINSTALL SALVAGED BRICK PAVERS AT PRECONSTRUCTION LOCATION AND CONDITION OR REPLACE IN-KIND.
- FEINSTALL SALVAGED LANDSCAPE BORDER AT PRECONSTRUCTION LOCATION AND CONDITION OR REPLACE IN-KIND.
- REINSTALL SALVAGED WOOD FENCE & GATE AT PRECONSTRUCTION LOCATION AND CONDITION OR REPLACE IN-KIND.
- REINSTALL SALVAGED ROCKERY AT PRECONSTRUCTION LOCATION AND CONDITION OR REPLACE IN-KIND.
- 9 RESTORE BARK MULCH PER RESTORATION TABLE, SHEET 37.
- (10) RESTORE, OR REPLACE IN-KIND, PEA GRAVEL PATH.
- REINSTALL SALVAGED WOOD FENCE IN SAME CONDITION BEHIND PROPOSED SIDEWALK IMPROVEMENTS OR REPLACE IN-KIND.

#### **LEGEND**

HARD SURFACE RESTORATION ON PRIVATE PROPERTY, SEE NOTES, THIS SHEET

SOFT SURFACE RESTORATION ON PRIVATE PROPERTY, SEE NOTES, THIS SHEET

PLANTER STRIP/LAWN WITHIN ROW

SCALE IN FEET

**CALL 2 DAYS BEFORE YOU DIG** 1-800-424-5555

BID **DOCUMENT** 




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					FINAL CONSTRUCTION CHECKED
C. K. HA					BY DATE
Tacoma					FIELD BOOKS
	NO	REVISION	DATE	APPD	



05/24

EH

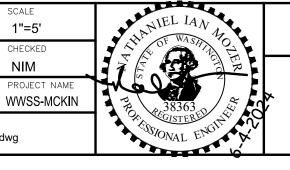948 McKinley Road.dwg


CITY	OF TACOMA	
ENVIRONMENTAL	SERVICES	DEPARTMENT

WASTEWATER SIDE SEWER IMPROVEMENTS MCKINLEY ROAD PRIVATE IMPROVEMENT RESTORATION PLAN

930 MCKINLEY ROAD

ENV-04018-08 PWK-00438-46

ES24-0034F

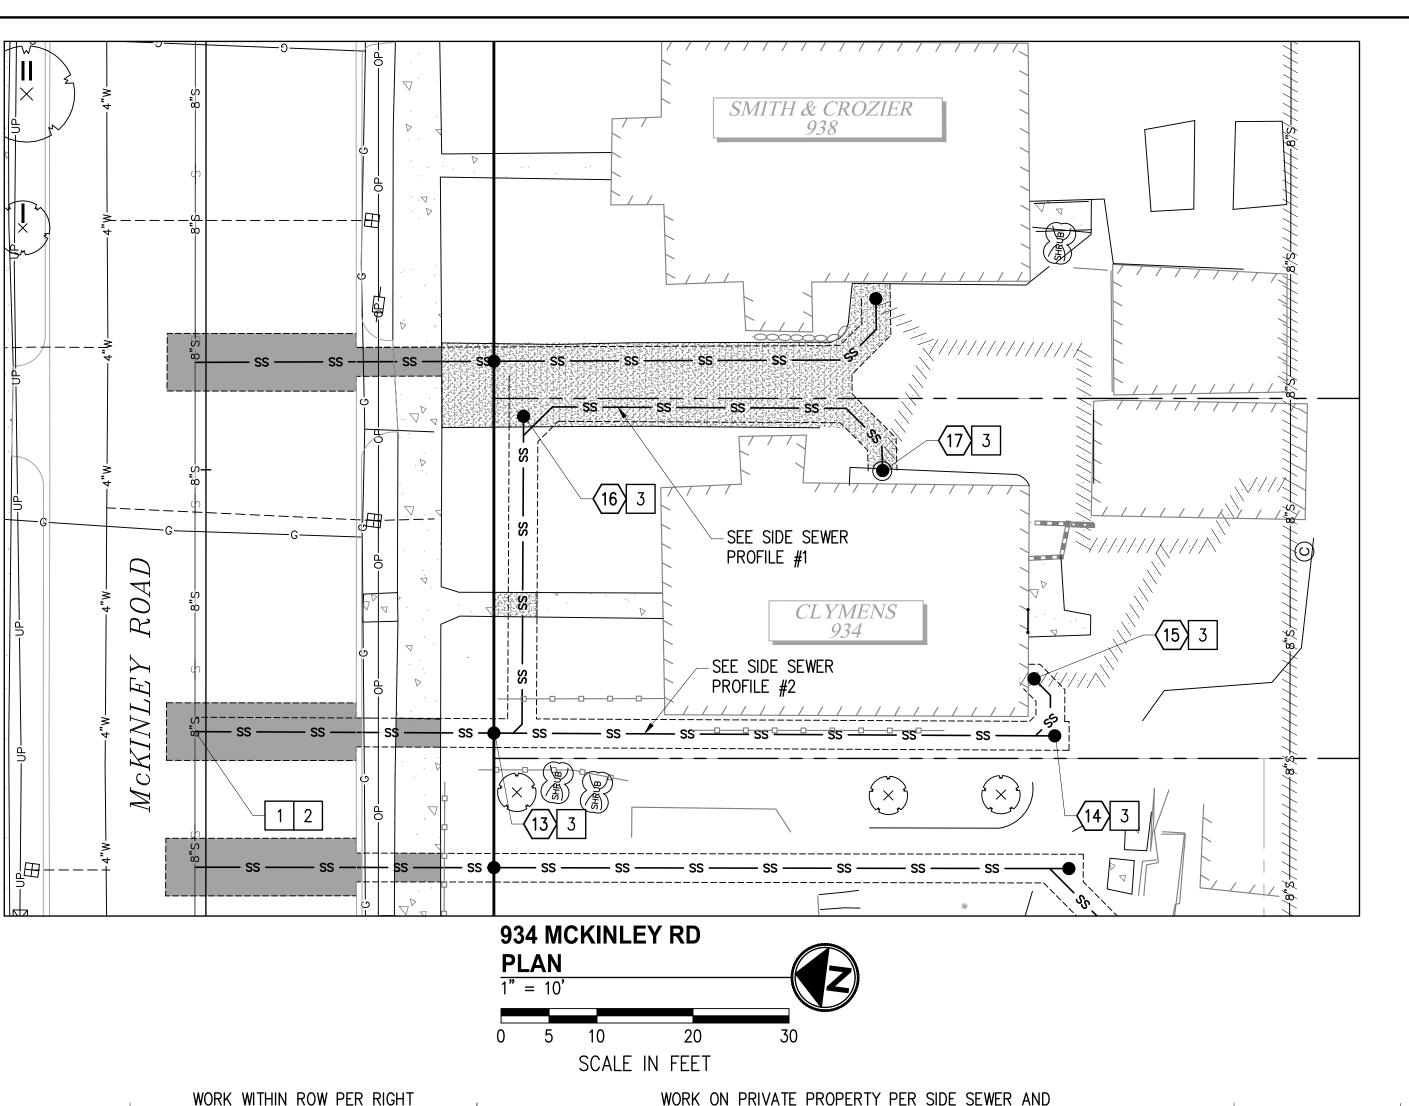

- 1 CONNECT TO EXISTING SEWER MAIN PER COT STANDARD PLAN SU-23.
- 2 CONSTRUCT PVC SIDE SEWER PER THE COT SIDE SEWER AND SANITARY SEWER AVAILABILITY MANUAL.
- 3 CONSTRUCT CLEANOUT PER COT STANDARD PLAN SU-24.

#### **LEGEND**

TEMPORARY HMA PATCH PER DETAIL 2, SHEET 37

TEMPORARY CSTC TRENCH PATCH PER DETAIL 3, SHEET 37


— ss — SIDE SEWER

SS CLEANOUT

SS CLEANOUT NUMBER

#### SIDE SEWER CONSTRUCTION STANDARDS

- 1. PIPE SIZE SHALL BE A MINIMUM OF 6" WITHIN ROW AND MINIMUM OF 4" ON PRIVATE PROPERTY.
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- 3. SIDE SEWERS SHALL HAVE A MINIMUM DEPTH OF 5' AT THE ROW
- 4. CLEANOUTS SHALL BE REQUIRED AT THE FOLLOWING LOCATIONS: -APPROXIMATELY 2' FROM THE BUILDING AT THE CHANGE FROM BUILDING DRAIN TO SIDE SEWER. -EVERY 135 DEGREES OF TOTAL BEND (INCLUDING HORZ. AND VERT.). -EVERY 100' OF PIPE RUN.
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#### **GENERAL NOTES**
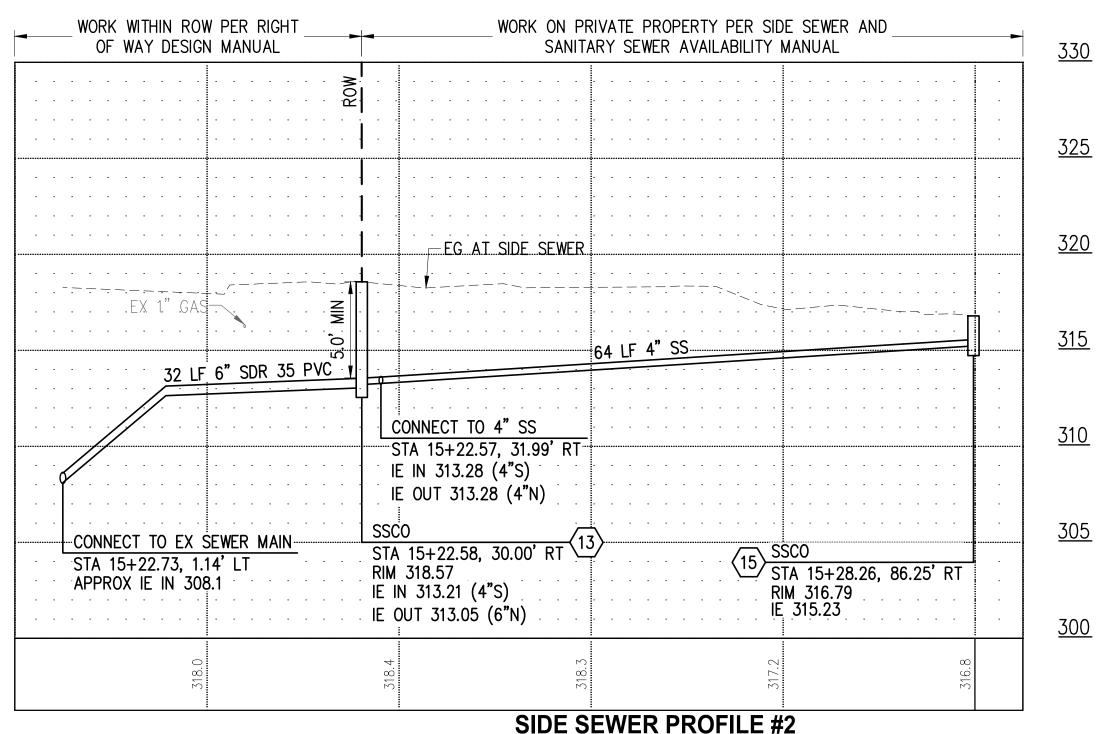
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**SIDE SEWER PROFILE #2** HOR: 1"=10' VER: 1"-5'

**CALL 2 DAYS BEFORE YOU DIG** 1-800-424-5555

BID **DOCUMENT** 

OF WAY DESIGN MANUAL



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**SIDE SEWER PROFILE #1** 

CONNECT TO 4" SS

IE IN 313.28 (4"S)

HOR: 1"=10' VER: 1"-5'

IE OUT 313.28 (4"N)

STA 15+22.57, 31.99' RT






SSC0 STA 15+49.93, 70.48' RT

RIM 322.76 IE 321.24

SANITARY SEWER AVAILABILITY MANUAL



<u>300</u>

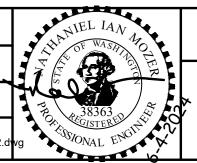





WASTEWATER SIDE SEWER IMPROVEMENTS MCKINLEY ROAD SIDE SEWER PLAN + PROFILE & TEMPORARY RESTORATION PLAN 934 MCKINLEY ROAD

ENV-04018-08 PWK-00438-46

ES24-0034F

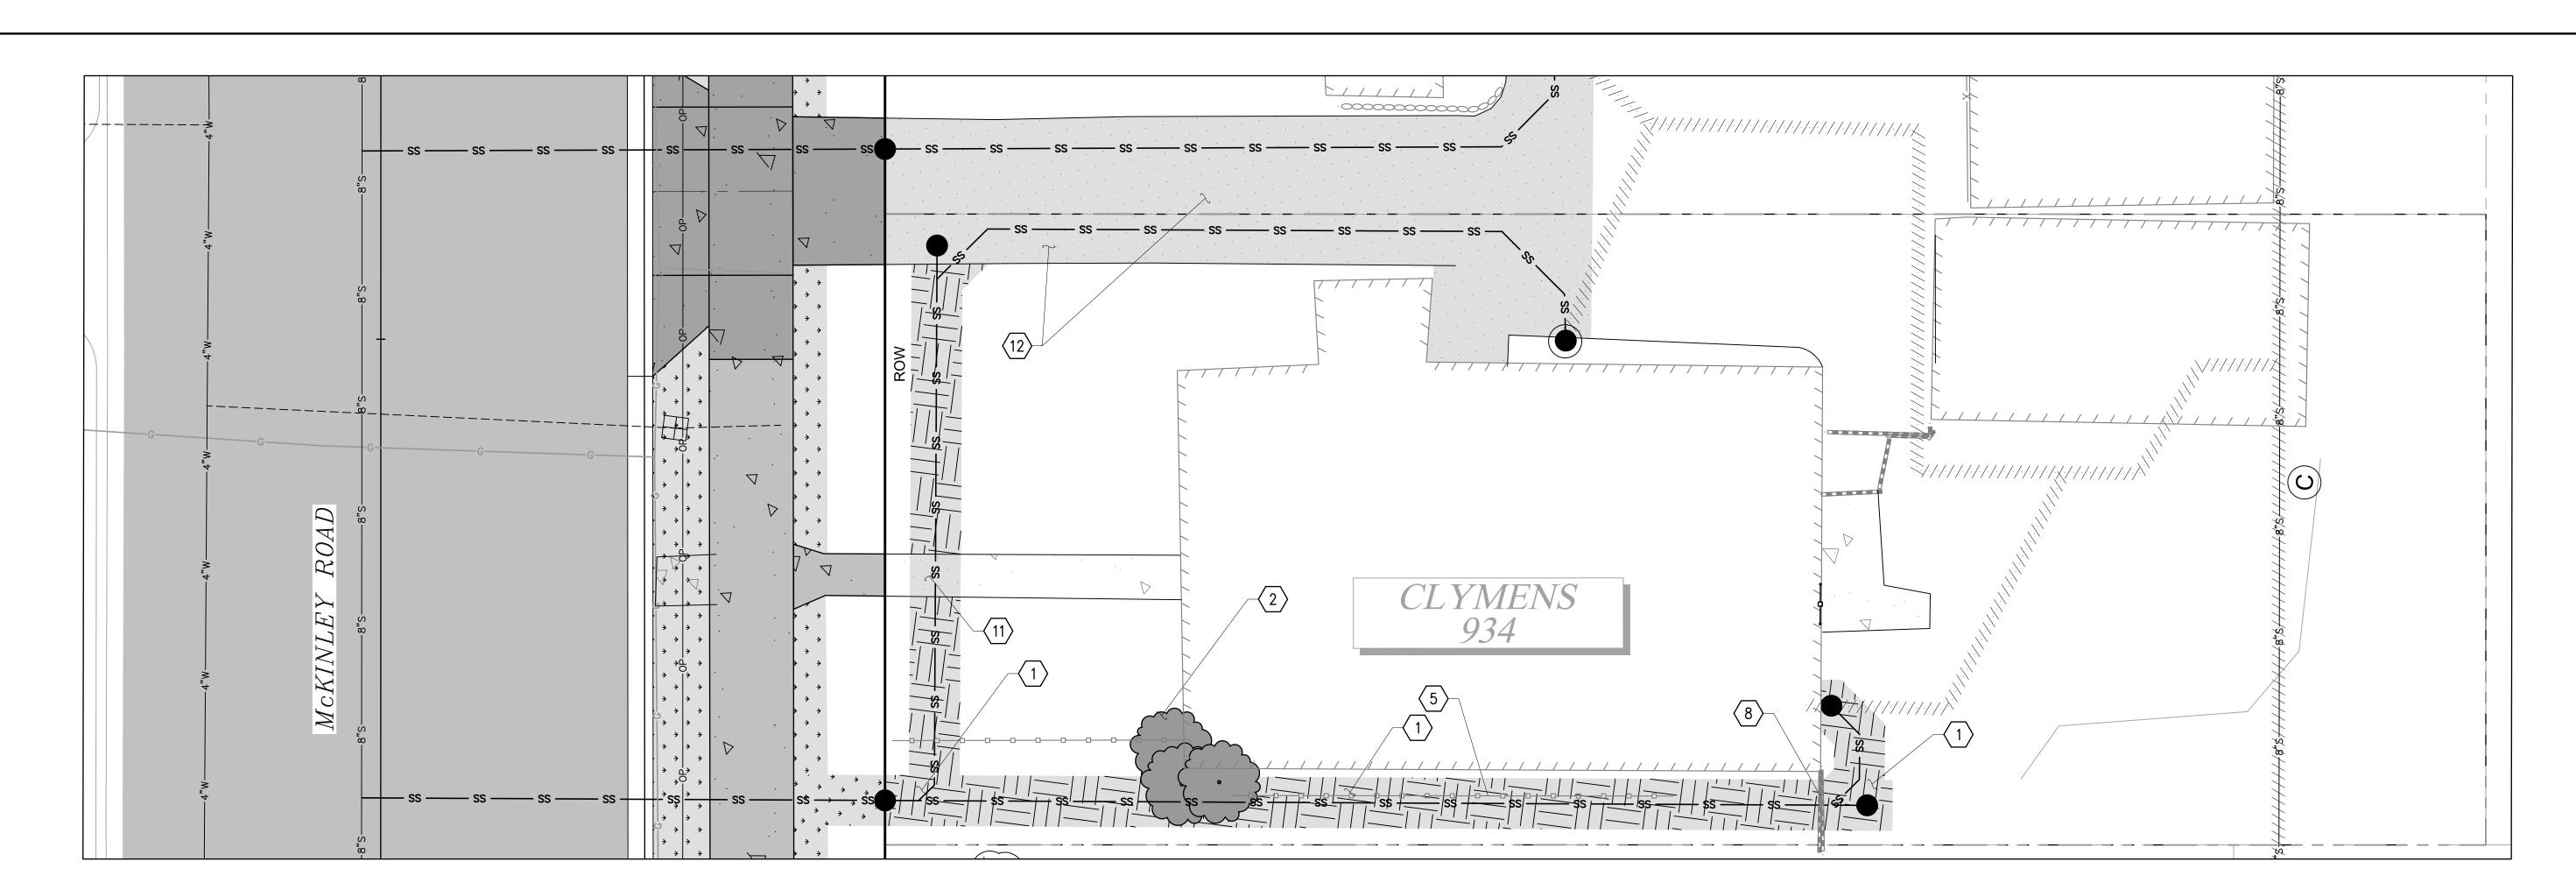

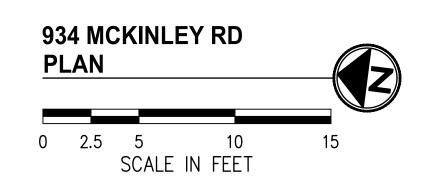

HARD SURFACE RESTORATION ON PRIVATE PROPERTY, SEE NOTES, THIS SHEET

SOFT SURFACE RESTORATION ON PRIVATE PROPERTY, SEE NOTES, THIS SHEET

PLANTER STRIP/LAWN WITHIN ROW

#### **GENERAL NOTES**

- 1. CONTRACTOR SHALL COORDINATE DIRECTLY WITH PROPERTY OWNER AND CITY INSPECTOR TO CONFIRM THE LOCATIONS AND TYPES OF MATERIALS TO USE DURING RESTORATION PRIOR TO BEGINNING THE WORK
- 2. FOR RESTORATION WITHIN ROW SEE SHEETS 29-31.


#### **CONSTRUCTION NOTES**

- $\langle 1 \rangle$  RESTORE LAWN PER RESTORATION TABLE, SHEET 37.
- 2 REPLANT SALVAGED TREE/SHRUB OR REPLACE IN-KIND.
- FEINSTALL SALVAGED LANDSCAPE BORDER AT PRECONSTRUCTION LOCATION AND CONDITION OR REPLACE IN-KIND.
- 8 CONSTRUCT CAST IN PLACE CONC. RETAINING WALL AT PRECONSTRUCTION LOCATION, HEIGHT, AND DIMENSIONS.
- $\langle 11 \rangle$  4" THICK CEMENT CONCRETE WALKWAY, MATCH EXISTING WIDTH.
- RECONSTRUCT DRIVEWAY APRON AT PRECONSTRUCTION LOCATION PER SECTION B, SHEET 36. APRON RESTORATION EXTENTS SHALL MATCH PRECONSTRUCTION EXTENTS. ADD EXPANSION JOINTS AT 8' SPACING.


CALL 2 DAYS BEFORE YOU DIG 1-800-424-5555 BID DOCUMENT





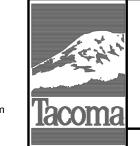

	NO	REVISION	DATE	APPD		952 McKinley Road.	dwg
coma					FIELD BOOKS	DRAWING NAME	
					DATE	DRAWN <b>EH</b>	PROJECT NAI
C.Y.					BY	EH	NIM
						DESIGNED	CHECKED
					CONSTRUCTION CHECKED	05/24	1"=5'
					FINAL	DATE	SCALE

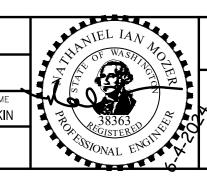


# CITY OF TACOMA ENVIRONMENTAL SERVICES DEPARTMENT

WASTEWATER SIDE SEWER IMPROVEMENTS MCKINLEY ROAD
PRIVATE IMPROVEMENT RESTORATION PLAN
934 MCKINLEY ROAD

ENV-04018-08 PWK-00438-46

ES24-0034F

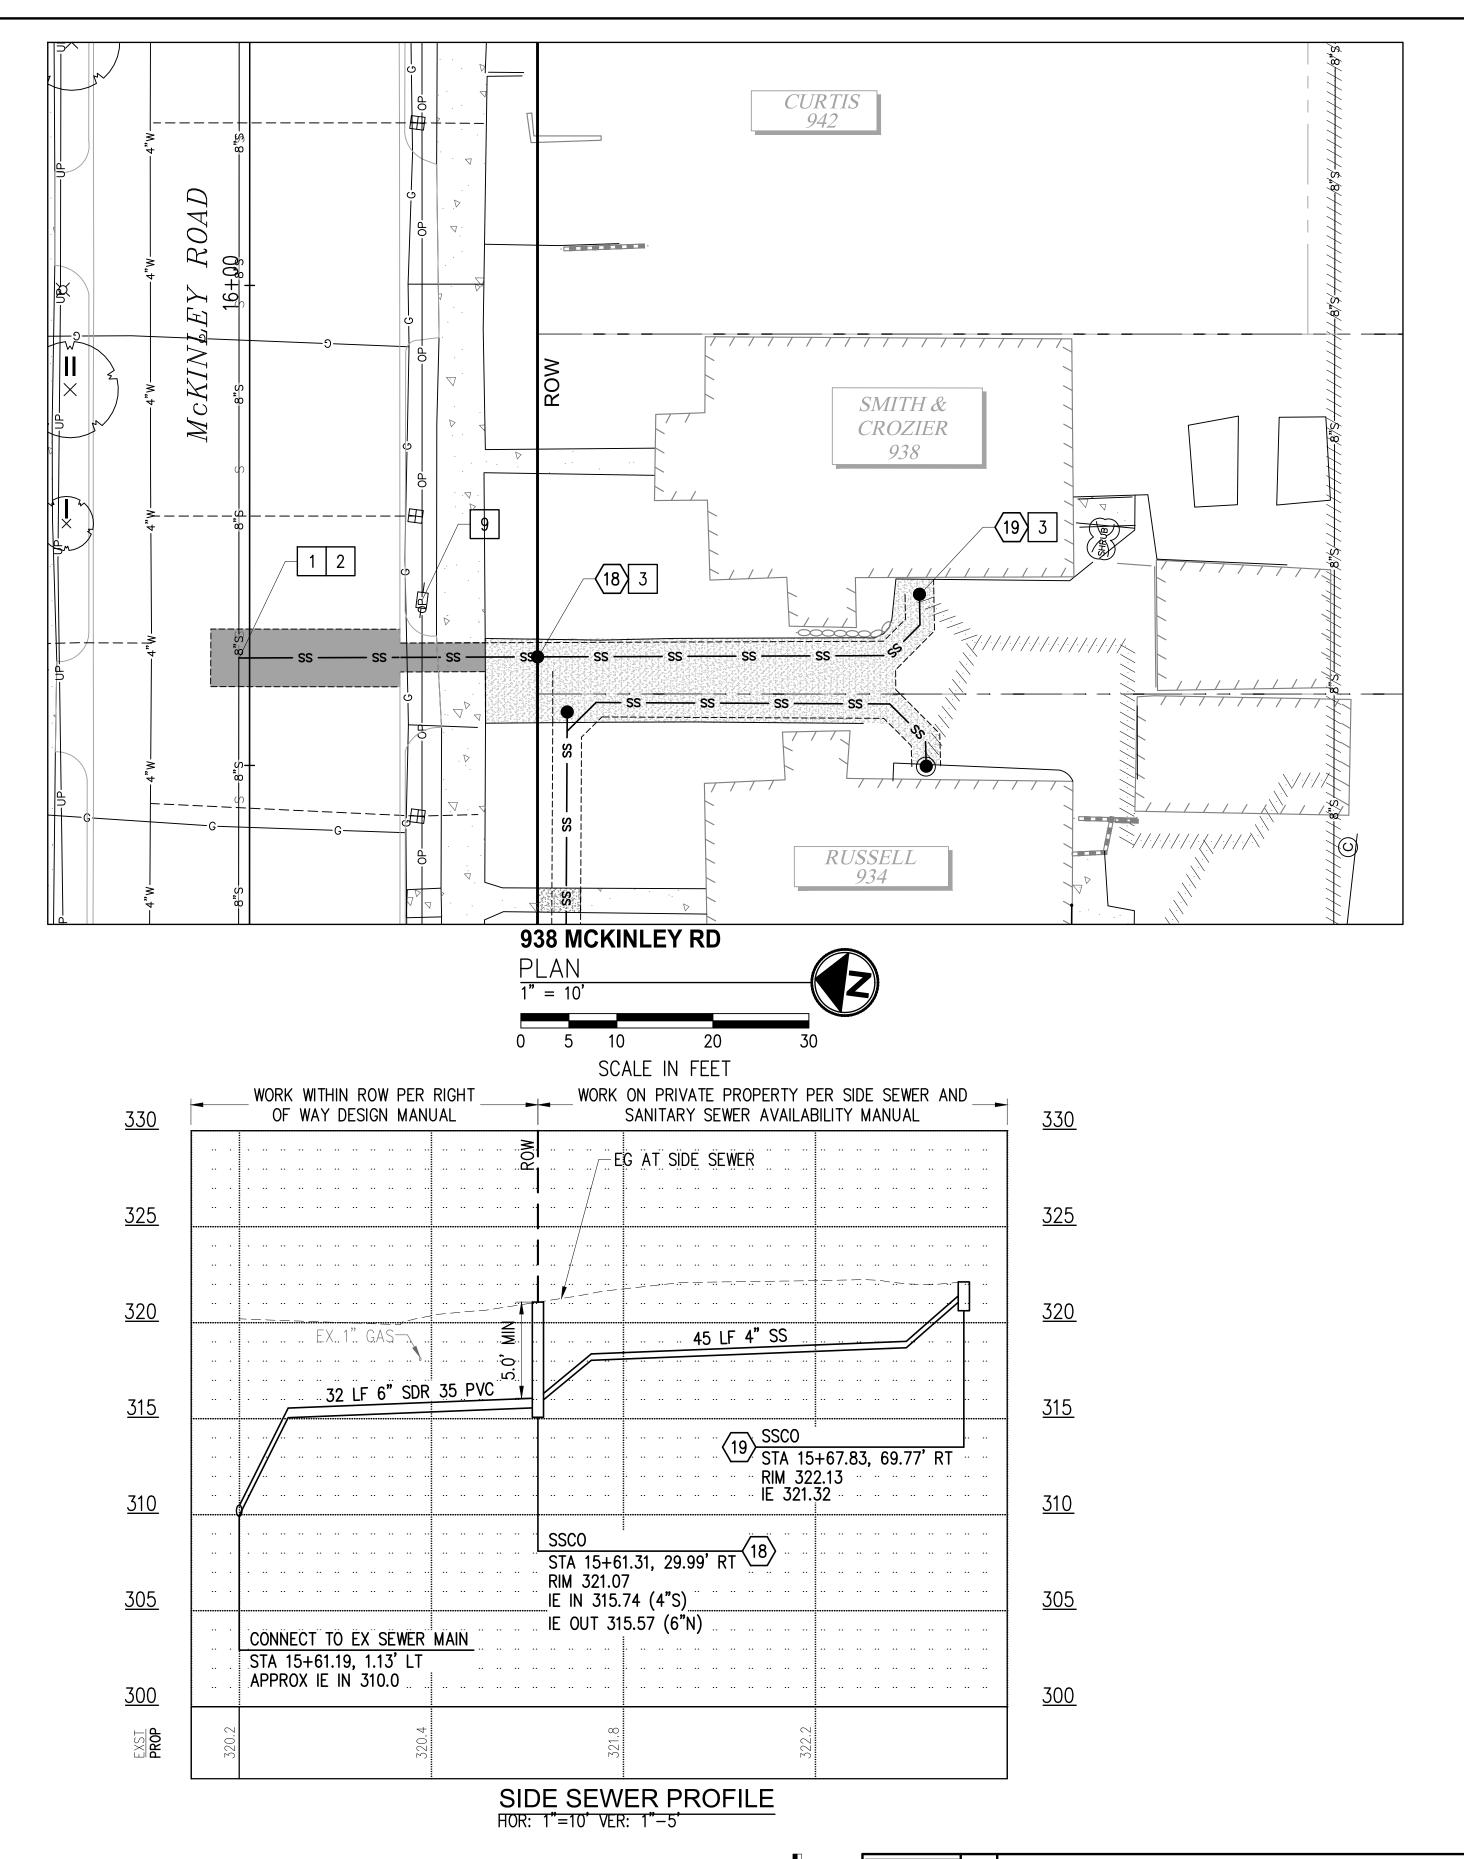

- 1 CONNECT TO EXISTING SEWER MAIN PER COT STANDARD PLAN SU-23.
- 2 CONSTRUCT PVC SIDE SEWER PER THE COT SIDE SEWER AND SANITARY SEWER AVAILABILITY MANUAL.
- 3 CONSTRUCT CLEANOUT PER COT STANDARD PLAN SU-24.
- 9 LUMINAIRE/UTILITY POLE COORDINATE WITH TPU (SEE SPECIAL PROVISION 1-07.17).

#### **LEGEND**



TEMPORARY HMA PATCH PER DETAIL 2, SHEET 37



TEMPORARY CSTC TRENCH PATCH PER DETAIL 3, SHEET 37

— ss — SIDE SEWER

SS CLEANOUT



SS CLEANOUT NUMBER

#### SIDE SEWER CONSTRUCTION STANDARDS

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- 4. CLEANOUTS SHALL BE REQUIRED AT THE FOLLOWING LOCATIONS: -APPROXIMATELY 2' FROM THE BUILDING AT THE CHANGE FROM BUILDING DRAIN TO SIDE SEWER. -EVERY 135 DEGREES OF TOTAL BEND (INCLUDING HORZ. AND VERT.). -EVERY 100' OF PIPE RUN.
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- 8. CONTRACTOR SHALL BE RESPONSIBLE FOR LOCATING EXISTING UTILITIES ON PRIVATE PROPERTY.

CALL 2 DAYS **BEFORE YOU DIG** 1-800-424-5555

BID **DOCUMENT** 



Tacoma, WA 98402 253.627.0720


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CONSTRUCTION CHECKED 05/24 AS NOTED WWSS-MCKIN NV-04018-08-05 Side Sewers 01.c DATE







WASTEWATER SIDE SEWER IMPROVEMENTS MCKINLEY ROAD SIDE SEWER PLAN + PROFILE & TEMPORARY RESTORATION PLAN 938 MCKINLEY ROAD

ES24-0034F ENV-04018-08

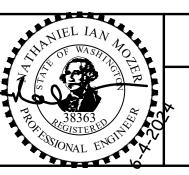PWK-00438-46

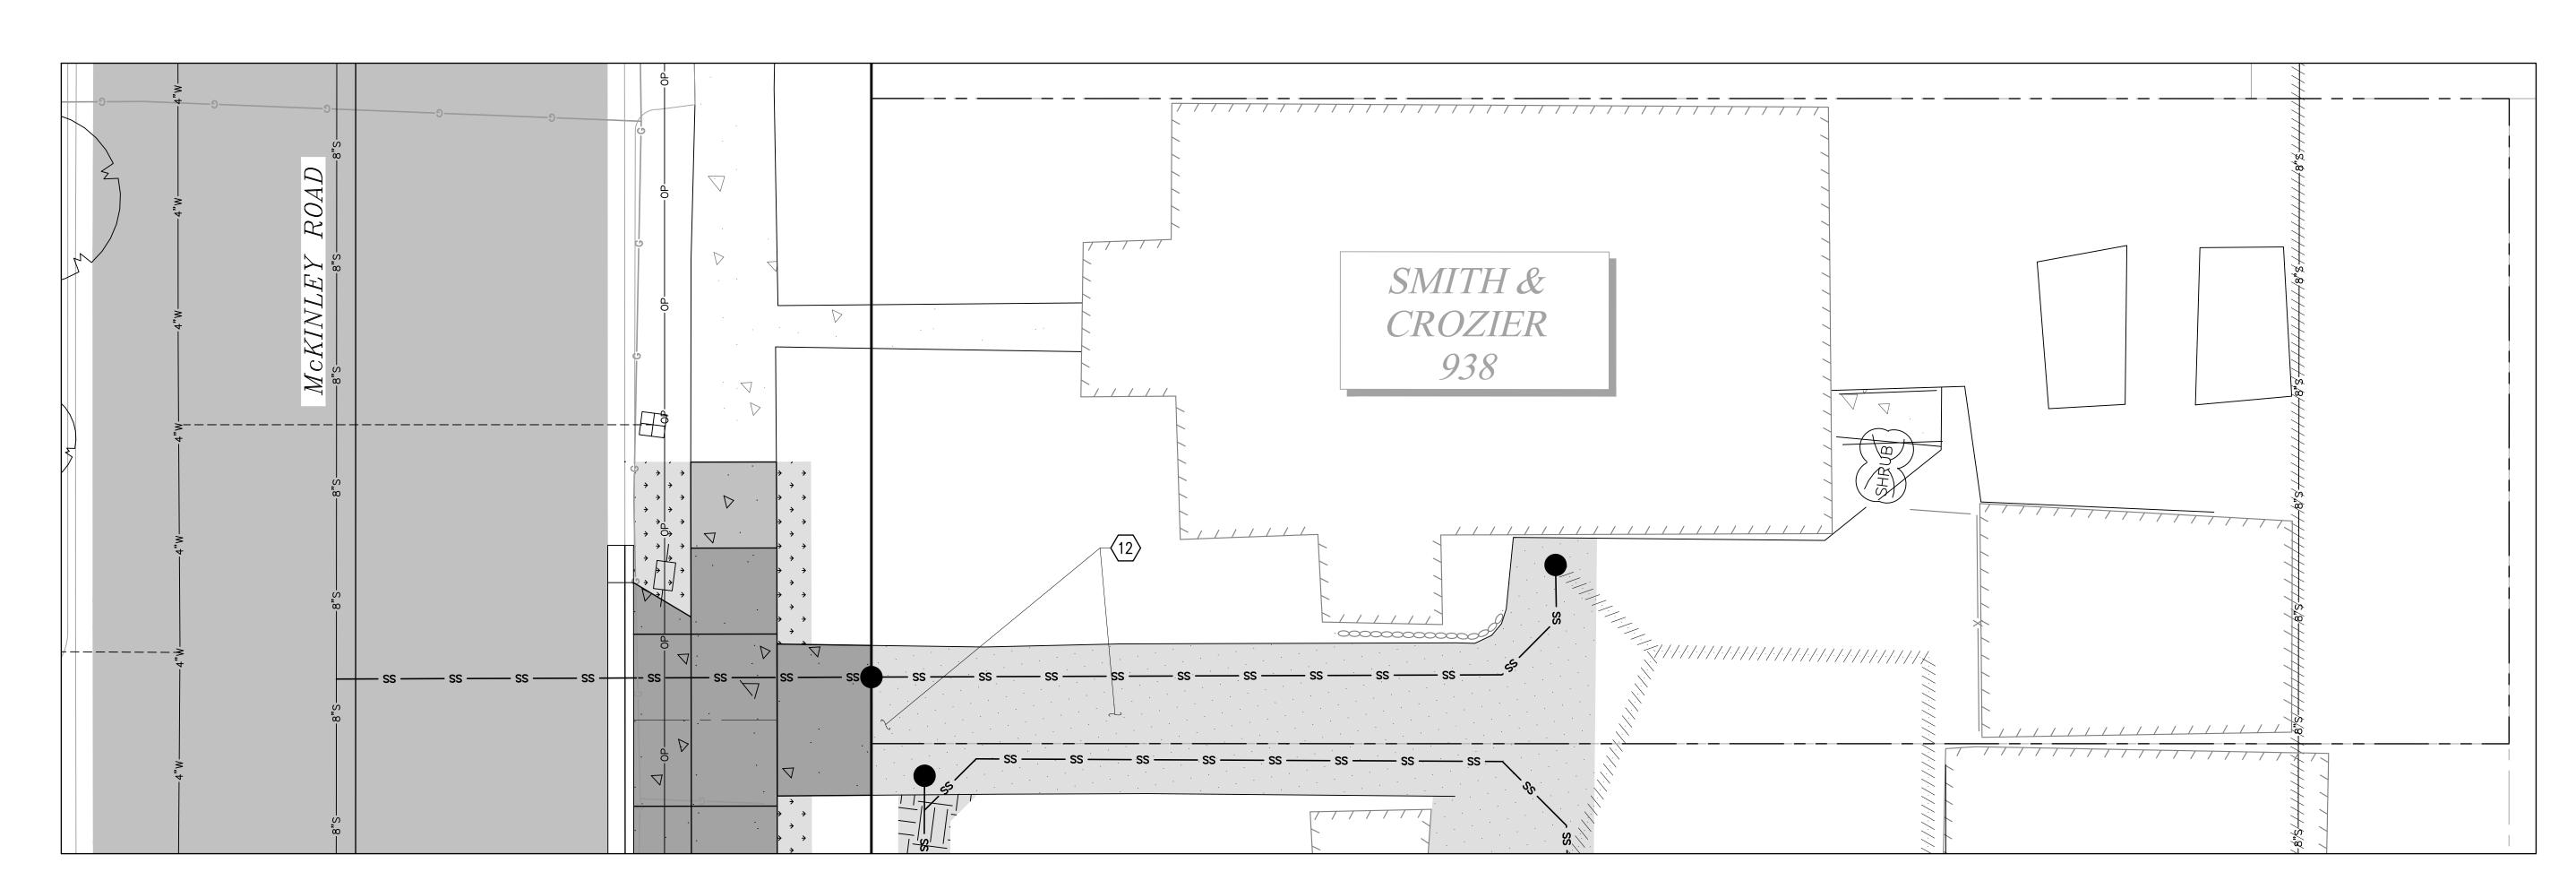

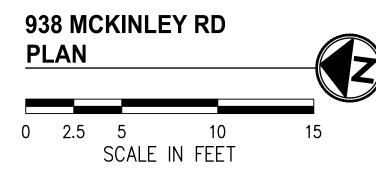

#### **LEGEND** HARD SURFACE RESTORATION ON PRIVATE PROPERTY, SEE NOTES, THIS SHEET

SOFT SURFACE RESTORATION ON PRIVATE PROPERTY, SEE NOTES, THIS SHEET

PLANTER STRIP/LAWN WITHIN ROW

#### **GENERAL NOTES**

- 1. CONTRACTOR SHALL COORDINATE DIRECTLY WITH PROPERTY OWNER AND CITY INSPECTOR TO CONFIRM THE LOCATIONS AND TYPES OF MATERIALS TO USE DURING RESTORATION PRIOR TO BEGINNING THE
- 2. FOR RESTORATION WITHIN ROW SEE SHEETS 29-31.

#### **CONSTRUCTION NOTES**

RECONSTRUCT DRIVEWAY APRON AT PRECONSTRUCTION LOCATION PER SECTION B, SHEET 36. APRON RESTORATION EXTENTS SHALL MATCH PRECONSTRUCTION EXTENTS. ADD EXPANSION JOINTS AT 8' SPACING.

**CALL 2 DAYS BEFORE YOU DIG** 1-800-424-5555

BID **DOCUMENT** 




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					FINAL CONSTRUCTION CHECKED	DATE <b>05/24</b>	SCALE <b>1"=5</b> '
N. C.					BY	DESIGNED EH	CHECKED NIM
					DATE	drawn <b>EH</b>	PROJECT WWSS-M
ma					FIELD BOOKS	DRAWING NAME	
	NO	REVISION	DATE	APPD		948 McKinley Road.	dwg





CITY OF TACOMA
ENVIRONMENTAL SERVICES DEPARTMENT


WASTEWATER SIDE SEWER IMPROVEMENTS MCKINLEY ROAD PRIVATE IMPROVEMENT RESTORATION PLAN 938 MCKINLEY ROAD

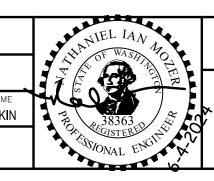ENV-04018-08 PWK-00438-46

ES24-0034F

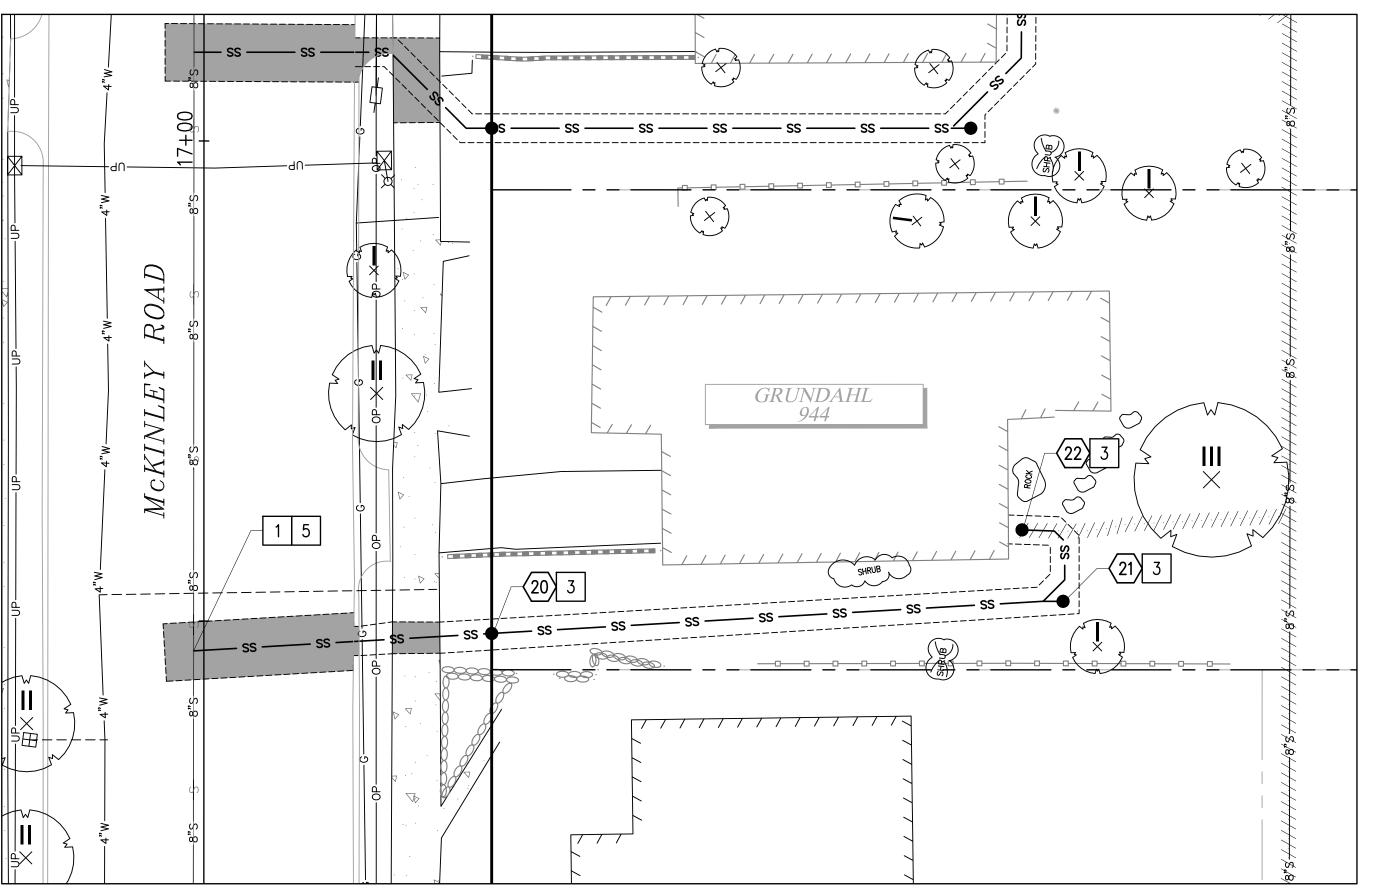

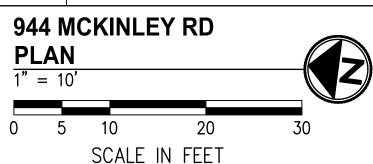

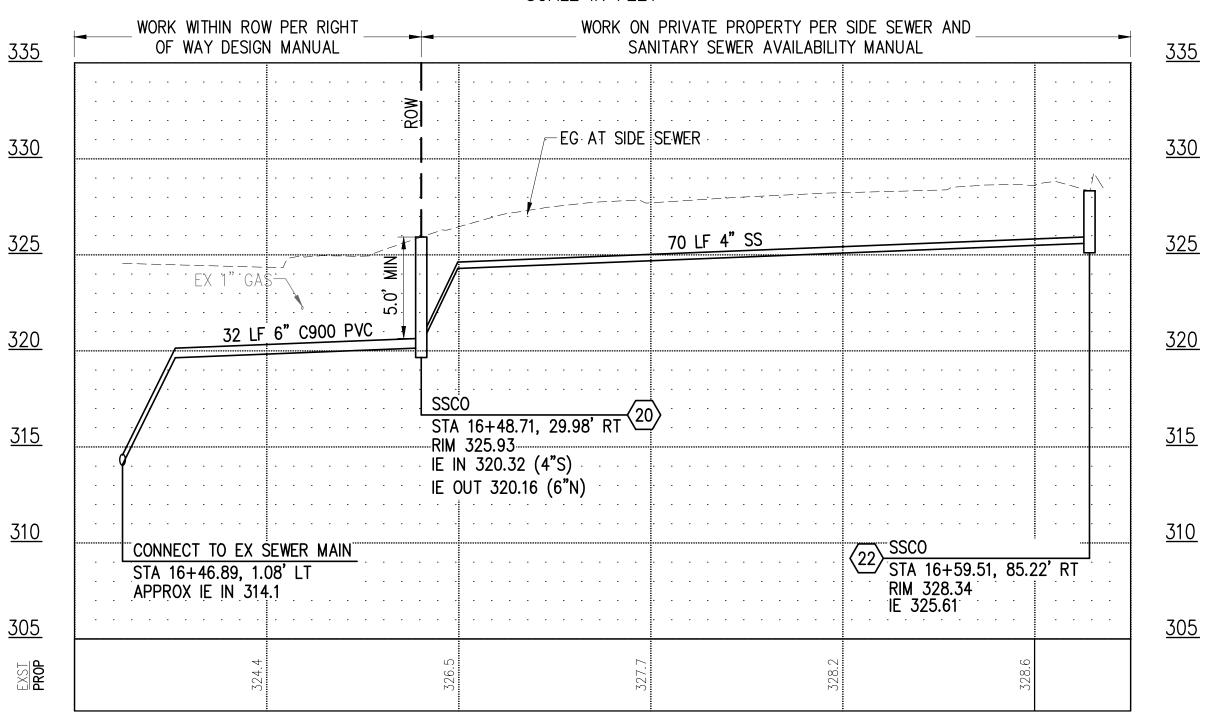

- 1 CONNECT TO EXISTING SEWER MAIN PER COT STANDARD PLAN SU-23.
- 3 CONSTRUCT CLEANOUT PER COT STANDARD PLAN SU-24.
- 5 CONSTRUCT C900 PVC SIDE SEWER PER THE COT SIDE SEWER AND SANITARY AVAILABILITY MANUAL.

#### **LEGEND**

TEMPORARY HMA PATCH PER DETAIL 2, SHEET 37

TEMPORARY CSTC TRENCH PATCH PER DETAIL 3, SHEET 37

—— ss —— SIDE SEWER

SS CLEANOUT

SS CLEANOUT NUMBER

#### SIDE SEWER CONSTRUCTION STANDARDS

- 1. PIPE SIZE SHALL BE A MINIMUM OF 6" WITHIN ROW AND MINIMUM OF 4" ON PRIVATE PROPERTY.
- 2. SIDE SEWER MINIMUM PIPE SLOPE IS 2.0%.
- 3. SIDE SEWERS SHALL HAVE A MINIMUM DEPTH OF 5' AT THE ROW
- 4. CLEANOUTS SHALL BE REQUIRED AT THE FOLLOWING LOCATIONS: -APPROXIMATELY 2' FROM THE BUILDING AT THE CHANGE FROM BUILDING DRAIN TO SIDE SEWER. -EVERY 135 DEGREES OF TOTAL BEND (INCLUDING HORZ. AND VERT.). -EVERY 100' OF PIPE RUN.
  - -EVERY CHANGE OF PIPE SIZE.
- -AT THE PROPERTY LINE.
- 5. PIPE SHALL HAVE MINIMUM DEPTH OF COVER OF 3' IN DRIVING

#### **GENERAL NOTES**

- 1. THE HORIZONTAL AND VERTICAL SIDE SEWER CONFIGURATION SHOWN ON THIS SHEET IS APPROXIMATE BASED ON THE INFORMATION AVAILABLE DURING DESIGN. THE CONTRACTOR MAY, WITH THE APPROVAL OF THE CONSTRUCTION INSPECTOR, ADJUST THE SIDE SEWER ALIGNMENT AS NEEDED TO BETTER ACCOMMODATE CONSTRUCTION METHODS AND CONDITIONS EXPERIENCED DURING CONSTRUCTION.
- 2. ALL EXISTING UTILITY INFORMATION INCLUDING MATERIAL, DEPTH. AND LOCATION ARE BASED ON AVAILABLE INFORMATION WITHOUT POTHOLING AND IS SOLELY FOR THE CONTRACTOR'S BENEFIT. INVERT ELEVATIONS FOR UTILITY CROSSINGS SHOWN ON PROFILES ARE ESTIMATED BASED ON RECORD DRAWINGS, GIS, OR OTHER DATA AND MAY NOT BE ACCURATE. INVERT ELEVATIONS FOR SOME UTILITY CROSSINGS ARE NOT AVAILABLE; THESE UTILITIES ARE SHOWN ON THE PROFILES IN THEIR APPROX. HORIZONTAL LOCATION TO ALERI THE CONTRACTOR OF THEIR EXISTENCE. THE CONTRACTOR SHALL POTHOLE UTILITY CROSSINGS & CONNECTION POINTS AT THE LOCATIONS SPECIFIED HEREIN A MINIMUM OF 5 WORKING DAYS PRIOR TO BEGINNING UTILITY IMPROVEMENTS TO VERIFY HORIZONTAL/VERTICAL LOCATION AND MATERIAL. CONTRACTOR SHALL NOTIFY THE ENGINEER IMMEDIATELY IN THE EVENT OF CONFLICT.
- 3. CONTRACTOR SHALL BE RESPONSIBLE FOR DETERMINING ALL PIPE AND FITTINGS REQUIRED TO REALIGN PLUMBING WITHIN EXISTING BASEMENTS/CRAWL SPACES WHERE SPECIFIED ON THE PLANS.
- 4. SIDE SEWERS WITHIN 10' HORIZONTALLY OR 18" VERTICALLY OF EXISTING WATER SERVICE SHALL BE CONSTRUCTED WITH C900 PVC SEWER PIPE.
- 5. THE EXISTING SIDE SEWER PIPE MATERIAL(S) IS UNKNOWN. CONTRACTOR SHALL BE RESPONSIBLE FOR DETERMINING EXISTING PIPE MATERIALS AND PROVIDING AN APPROPRIATE COUPLING TO TRANSITION FROM EXISTING TO PROPOSED SIDE SEWER PIPE
- 6. CONSTRUCTION MAY REQUIRE EXCAVATION WITHIN 10 FEET OF UTILITY POLES. WHERE ANTICIPATED, CONTRACTOR SHALL CONTACT TACOMA POWER (253) 502-8991 AT LEAST 2 WEEKS IN ADVANCE OF ANY CONSTRUCTION ACTIVITY WITHIN 10 FEET OF AN EXISTING POLE TO COORDINATE AN ONSITE VISIT WITH A TPU FIELD INSPECTOR. SEE SPECIAL PROVISION SECTION 1-07.17 FOR ADDITIONAL DETAIL AND REQUIREMENTS.
- 7. CONSTRUCTION WILL REQUIRE EXCAVATION IMMEDIATELY ADJACENT TO EXISTING BUILDING AND STRUCTURES, THE MAJORITY OF WHICH WERE CONSTRUCTED IN THE 1920'S. IT IS THE CONTRACTOR'S RESPONSIBILITY TO PRESERVE AND PROTECT ALL BUILDINGS AND STRUCTURES AND TO MAKE SURE CONSTRUCTION METHODS, SHORING METHODS, AND COMPACTION METHODS ARE APPROPRIATE GIVEN THE LOCATION OF THE CONSTRUCTION AREA.
- 8. CONTRACTOR SHALL BE RESPONSIBLE FOR LOCATING EXISTING UTILITIES ON PRIVATE PROPERTY.

CALL 2 DAYS **BEFORE YOU DIG** 1-800-424-5555

BID **DOCUMENT** 






SIDE SEWER PROFILE


HOR: 1"=10' VER: 1"-5'





CONSTRUCTION CHECKED 05/24 AS NOTED **WWSS-MCKIN** :NV-04018-08-05 PS Side Sewers 0 REVISION DATE

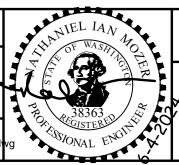

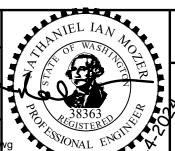



CITY OF TACOMA ENVIRONMENTAL SERVICES DEPARTMENT

WASTEWATER SIDE SEWER IMPROVEMENTS MCKINLEY ROAD SIDE SEWER PLAN + PROFILE & TEMPORARY RESTORATION PLAN 944 MCKINLEY ROAD

ENV-04018-08 PWK-00438-46

ES24-0034F

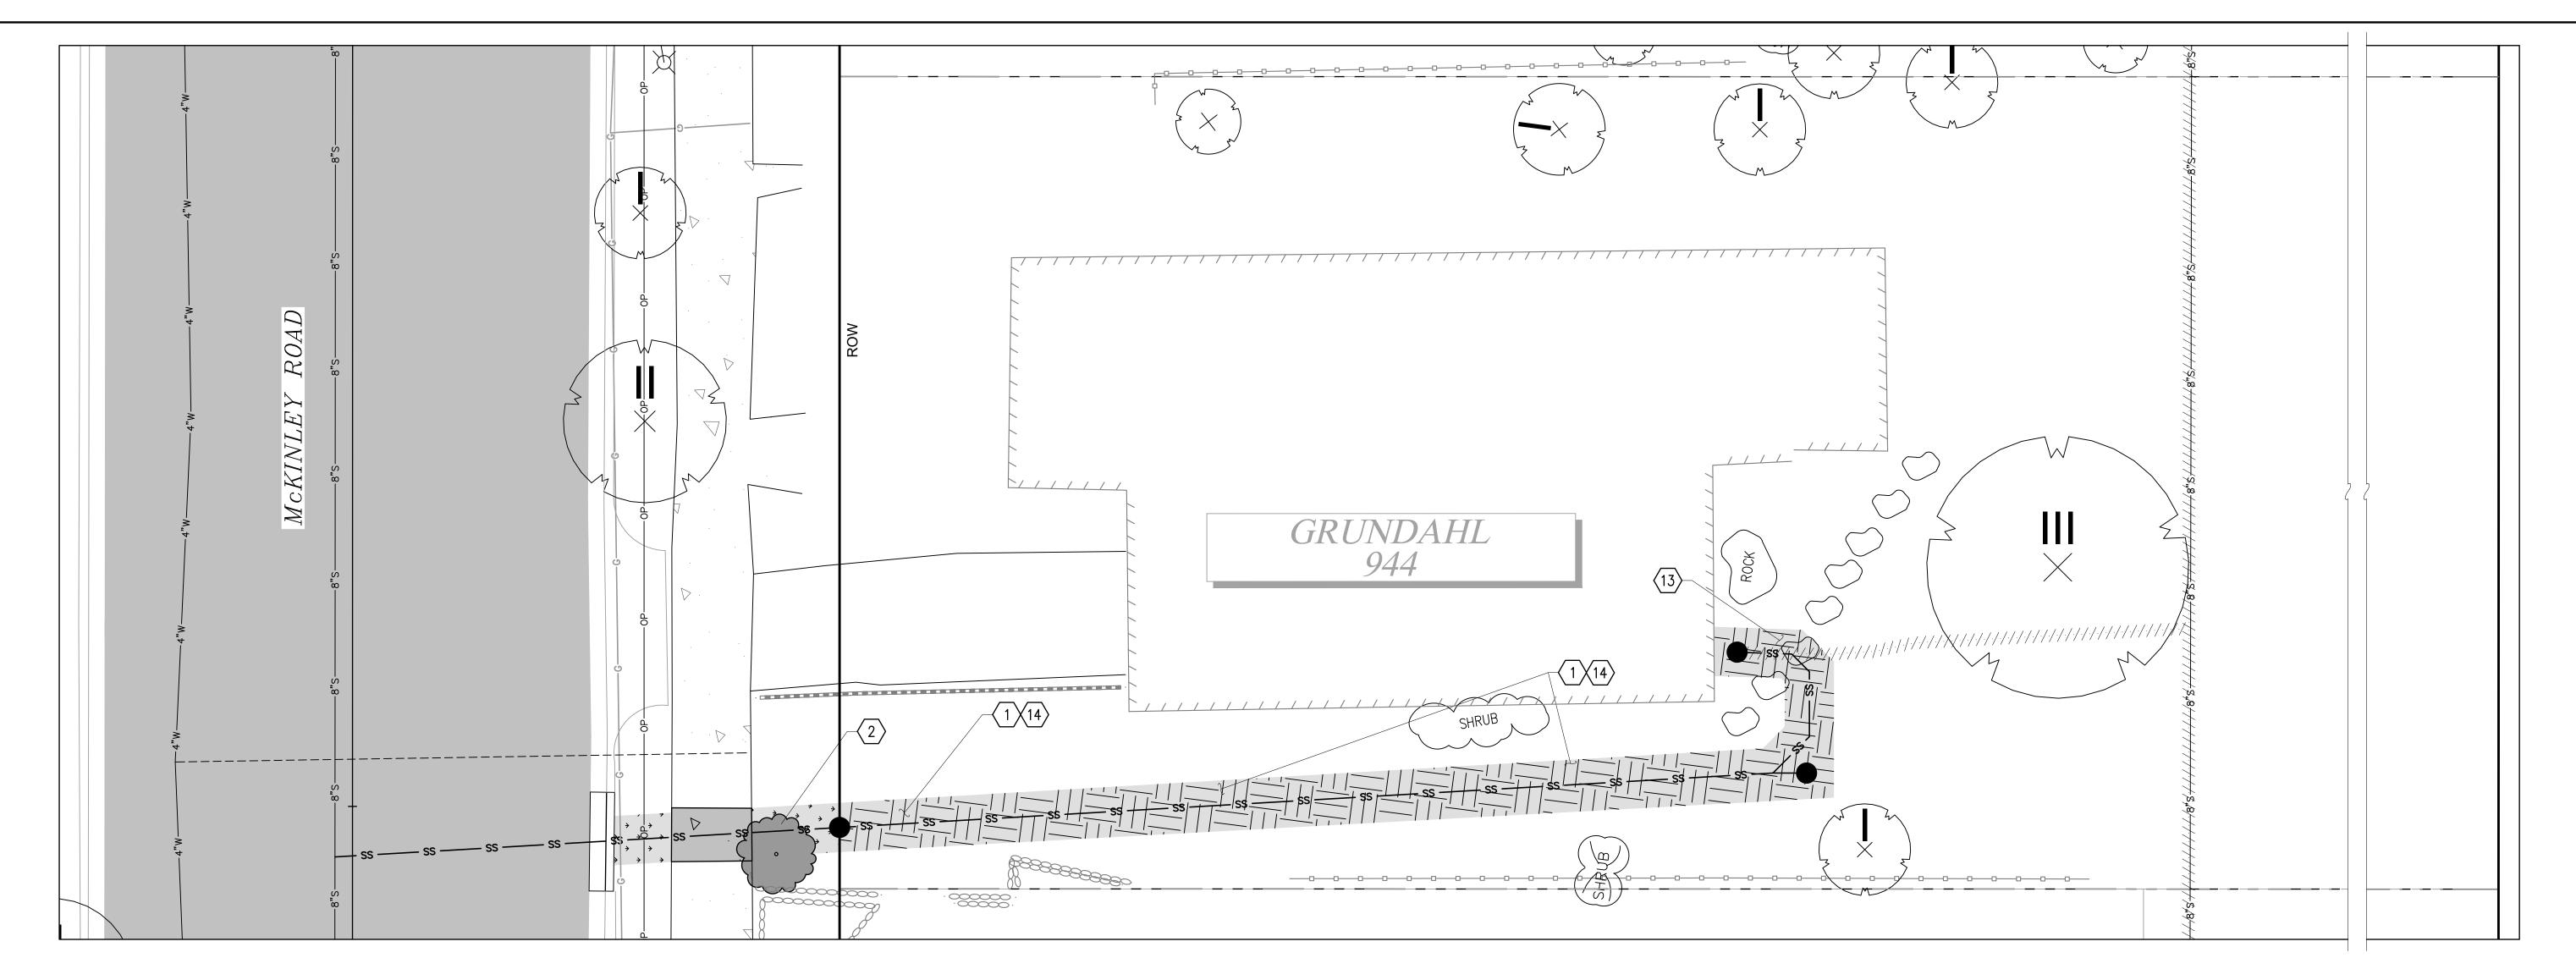

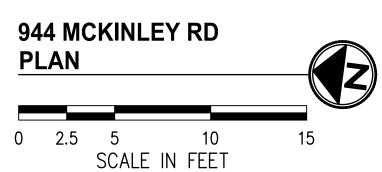

HARD SURFACE RESTORATION ON PRIVATE PROPERTY, SEE NOTES, THIS SHEET

SOFT SURFACE RESTORATION ON PRIVATE PROPERTY, SEE NOTES, THIS SHEET

PLANTER STRIP/LAWN WITHIN ROW

#### **GENERAL NOTES**

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FINAL CONSTRUCTION CHECKED

05/24

EH

EH

952 McKinley Road.dwg

1"=5'

2. FOR RESTORATION WITHIN ROW SEE SHEETS 29-31.

#### **CONSTRUCTION NOTES**

- $\langle 1 \rangle$  RESTORE LAWN PER RESTORATION TABLE, SHEET 37.
- 2 REPLANT SALVAGED TREE/SHRUB OR REPLACE IN-KIND.
- REINSTALL, OR REPLACE IN-KIND, SALVAGED FLAG STONES AT PRECONSTRUCTION LOCATION.
- GRADE SIDE YARD TO UNIFORM PLANE THAT SLOPES FROM SOUTH TO NORTH.


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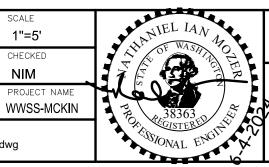
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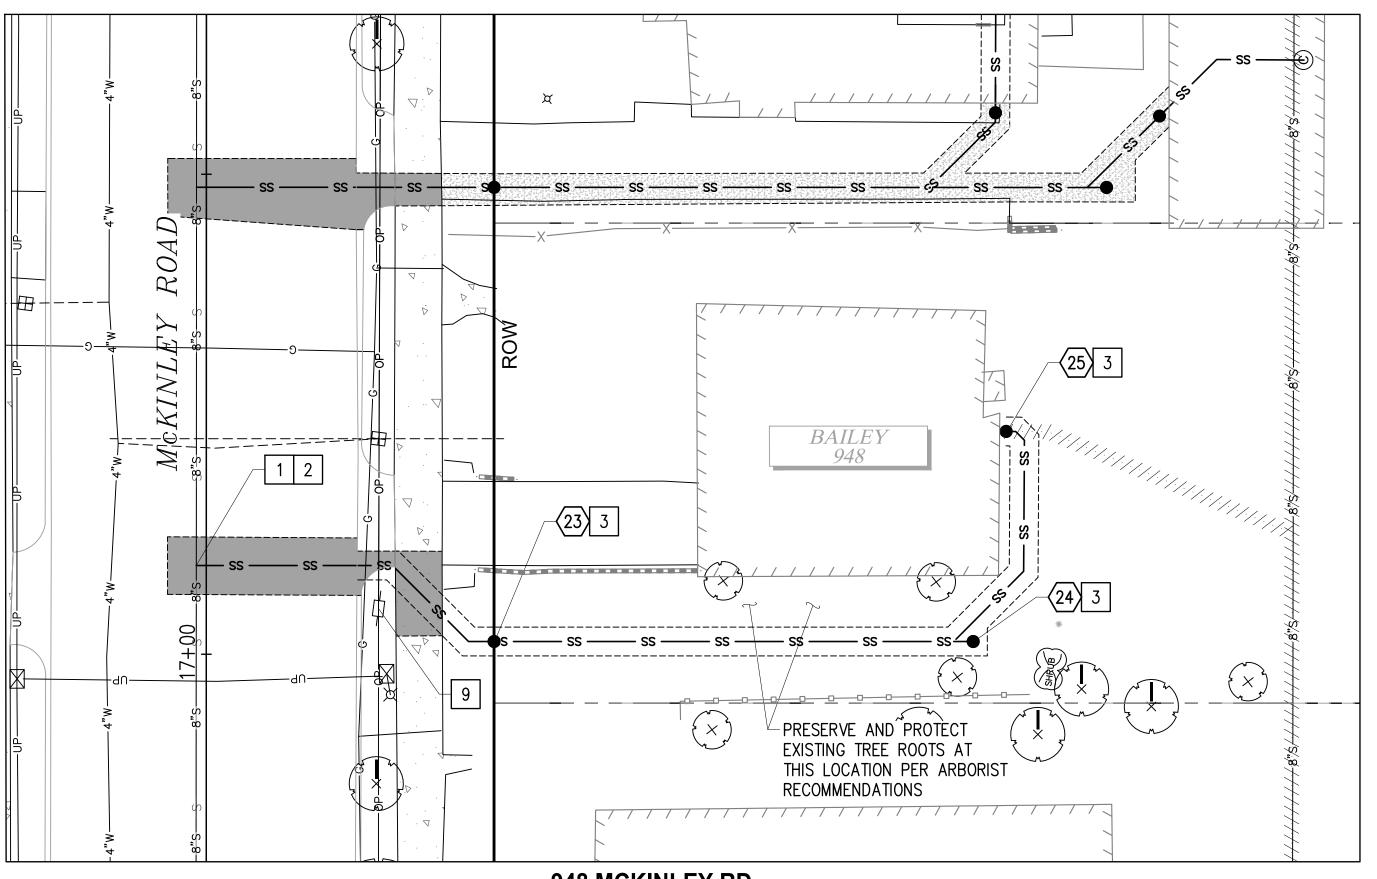








ENV-04018-08 PWK-00438-46

ES24-0034F

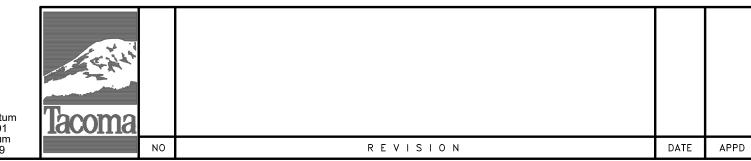

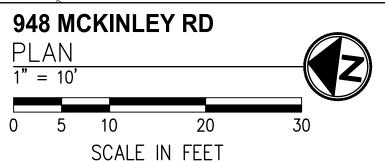

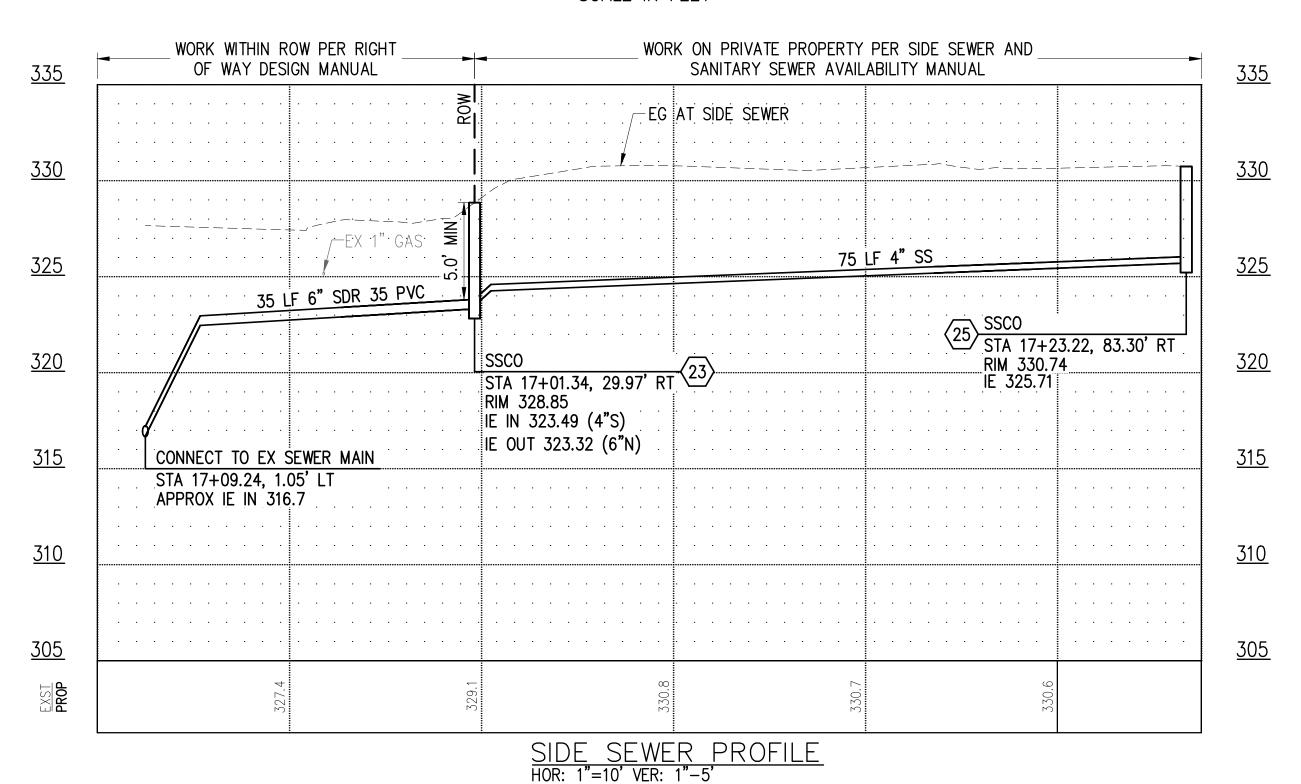

- 1 CONNECT TO EXISTING SEWER MAIN PER COT STANDARD PLAN SU-23.
- 2 CONSTRUCT PVC SIDE SEWER PER THE COT SIDE SEWER AND SANITARY SEWER AVAILABILITY MANUAL.
- 3 CONSTRUCT CLEANOUT PER COT STANDARD PLAN SU-24.
- 9 LUMINAIRE/UTILITY POLE COORDINATE WITH TPU (SEE SPECIAL PROVISION 1-07.17).


#### **LEGEND**



TEMPORARY HMA PATCH PER DETAIL 2. SHEET 37



TEMPORARY CSTC TRENCH PATCH PER DETAIL 3, SHEET 37

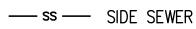

SS CLEANOUT



SS CLEANOUT NUMBER

#### SIDE SEWER CONSTRUCTION STANDARDS

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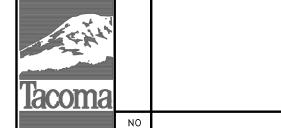
CALL 2 DAYS **BEFORE YOU DIG** 1-800-424-5555

BID **DOCUMENT** 










	NO	REVISION	DATE	APPD			
oma					FIELD BOOKS	DRAWING NAME ENV-04018-08-05 S	ide Sewers 01
0.700.0					DATE	EH	WWSS-MCK
and the same					DATE	DRAWN	PROJECT NAM
A. 14.					BY	EH	NIM
						DESIGNED	CHECKED
					CHECKED	05/24	AS NOTE
					FINAL CONSTRUCTION	DATE	SCALE

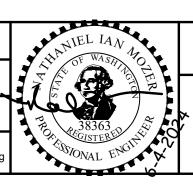



CITY OF TACOMA ENVIRONMENTAL SERVICES DEPARTMENT

WASTEWATER SIDE SEWER IMPROVEMENTS MCKINLEY ROAD SIDE SEWER PLAN + PROFILE & TEMPORARY RESTORATION PLAN 948 MCKINLEY ROAD

ENV-04018-08 PWK-00438-46

ES24-0034F

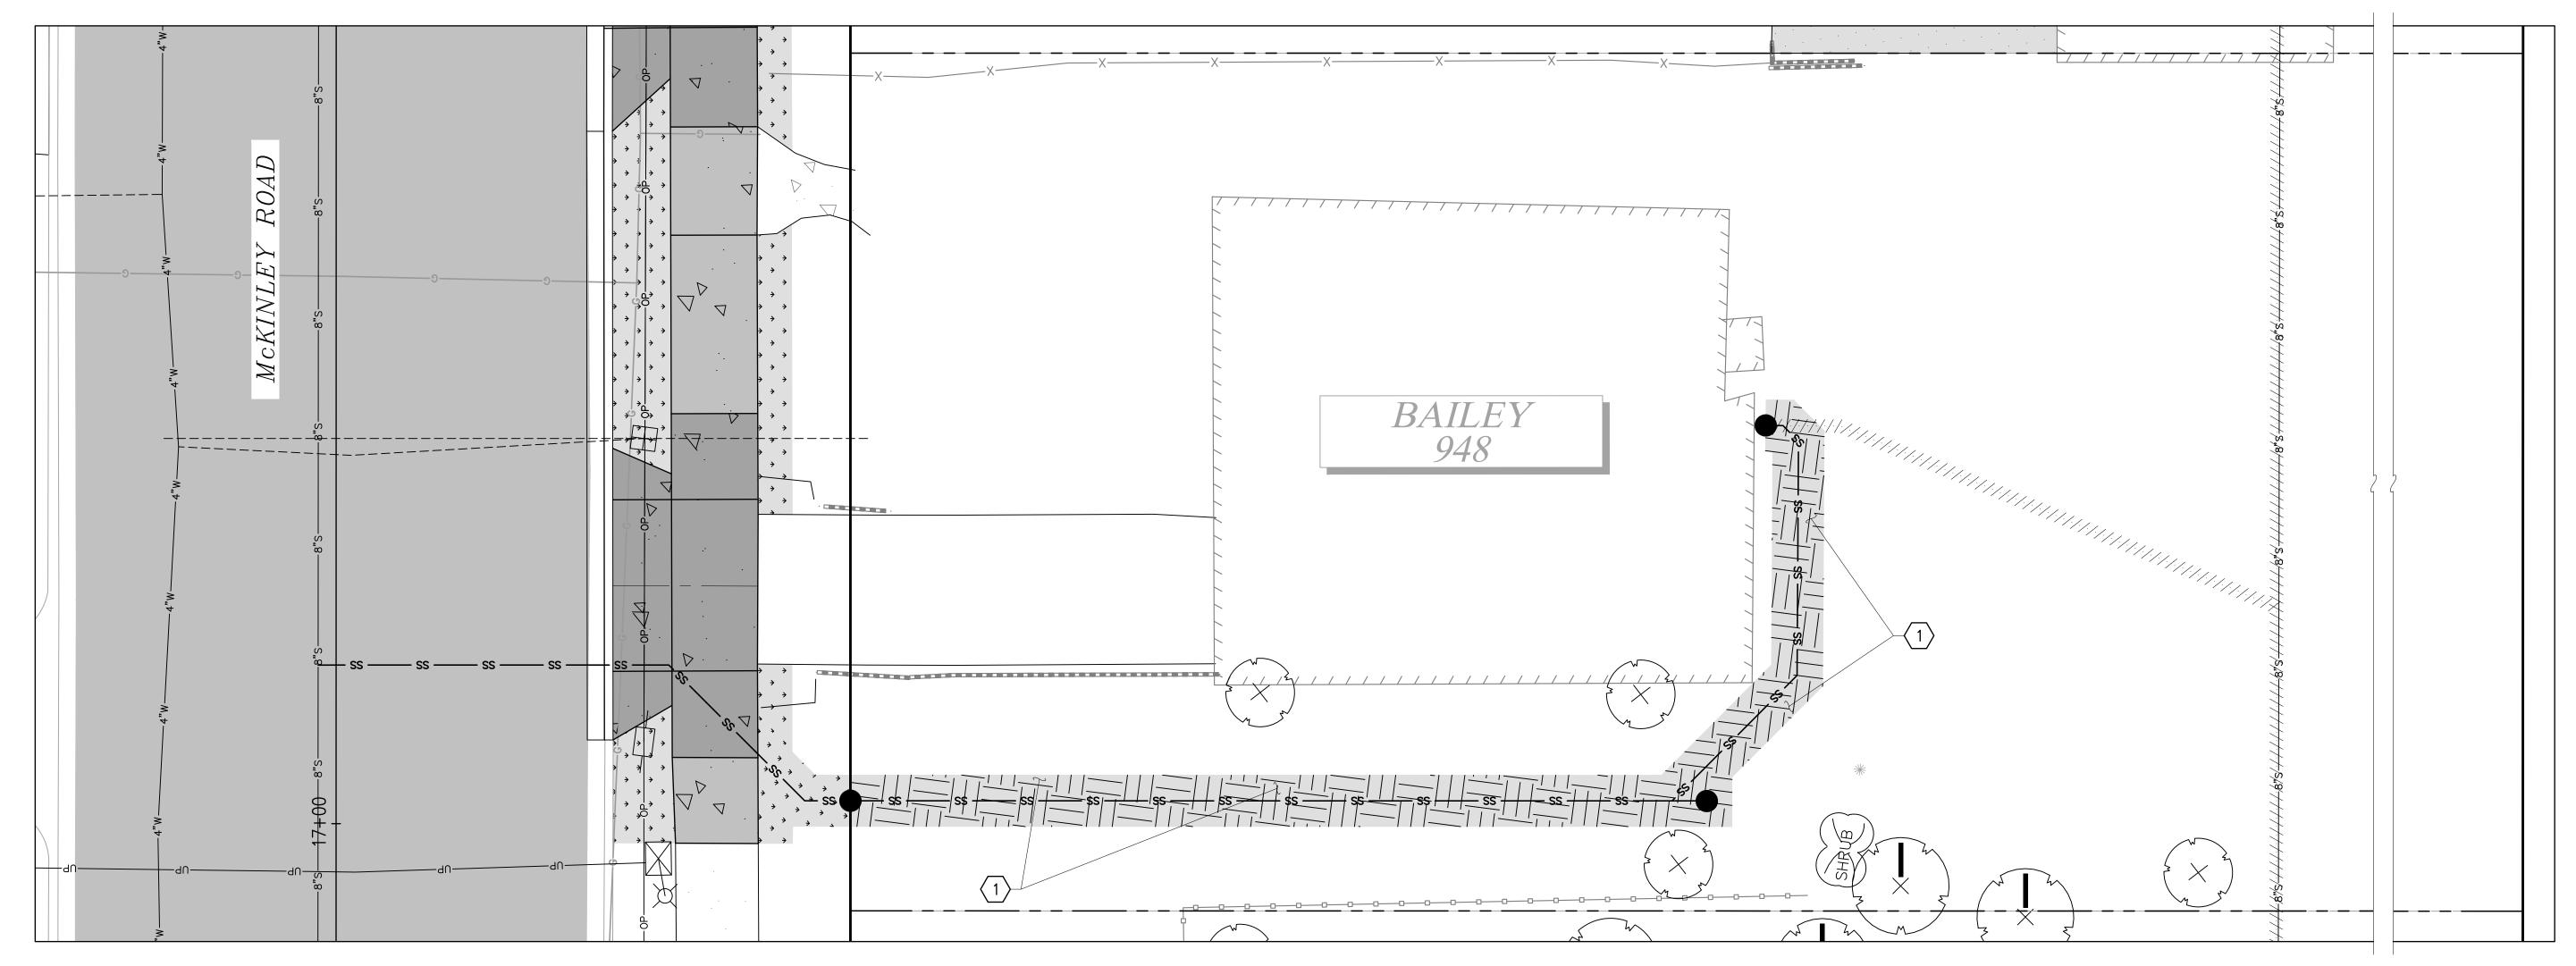

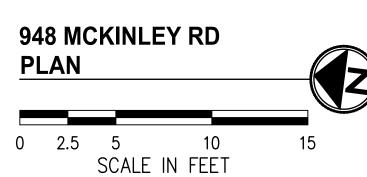

HARD SURFACE RESTORATION ON PRIVATE PROPERTY, SEE NOTES, THIS SHEET

SOFT SURFACE RESTORATION ON PRIVATE PROPERTY, SEE NOTES, THIS SHEET

PLANTER STRIP/LAWN WITHIN ROW

#### **GENERAL NOTES**

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- 2. FOR RESTORATION WITHIN ROW SEE SHEETS 29-31.

### **CONSTRUCTION NOTES**

1 RESTORE LAWN PER RESTORATION TABLE, SHEET 37.


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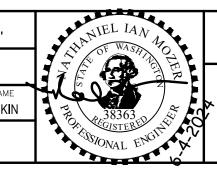









			DRAWN	PROJECT NA
		BY	EH	NIM
3			DESIGNED	CHECKED
		FINAL CONSTRUCTION CHECKED	05/24	SCALE 1"=5'

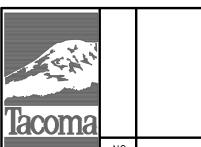





ENV-04018-08 PWK-00438-46

ES24-0034F

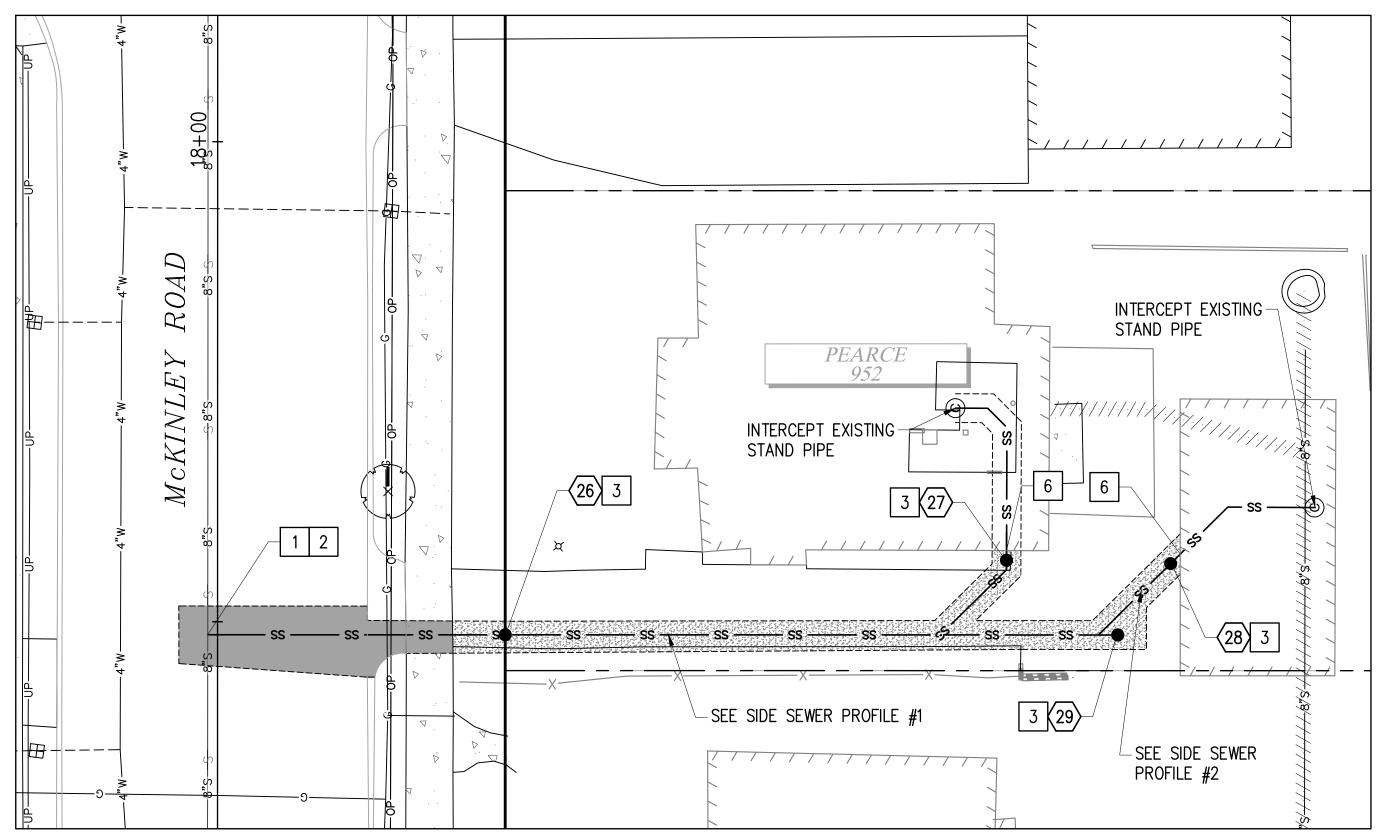

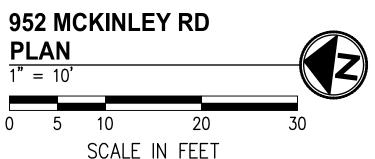

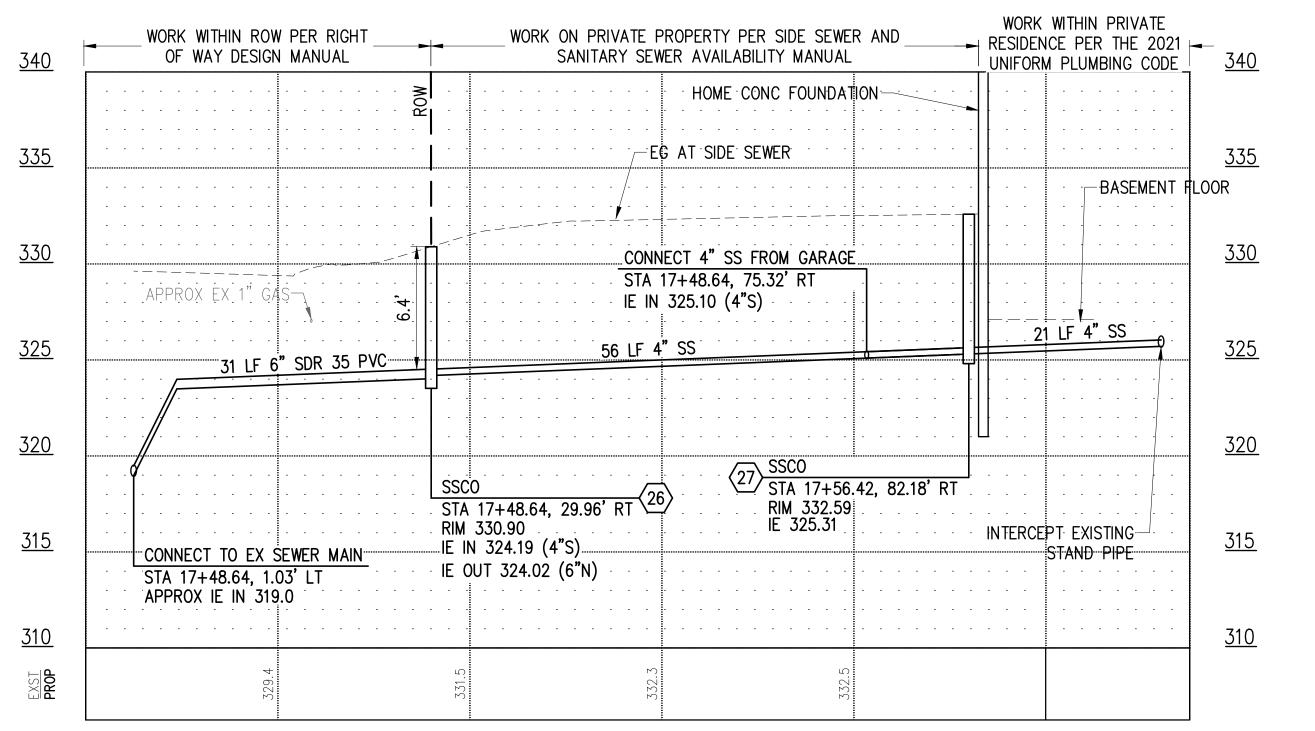

#### **SIDE SEWER PROFILE #1** HOR: 1"=10' VER: 1"-5'

#### **CONSTRUCTION NOTES**

- 1 CONNECT TO EXISTING SEWER MAIN PER COT STANDARD PLAN SU-23.
- 2 CONSTRUCT PVC SIDE SEWER PER THE COT SIDE SEWER AND SANITARY SEWER AVAILABILITY MANUAL.
- 3 CONSTRUCT CLEANOUT PER COT STANDARD PLAN SU-24.
- 6 CORE THROUGH EXISTING FOUNDATION AND INSTALL APPROPRIATELY igsqcup sized link seal to provide water tight penetration.

#### LEGEND



TEMPORARY HMA PATCH PER DETAIL 2. SHEET 37




— ss — SIDE SEWER

SS CLEANOUT

SS CLEANOUT NUMBER

#### SIDE SEWER CONSTRUCTION STANDARDS

- 1. PIPE SIZE SHALL BE A MINIMUM OF 6" WITHIN ROW AND MINIMUM OF 4" ON PRIVATE PROPERTY.
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- 3. SIDE SEWERS SHALL HAVE A MINIMUM DEPTH OF 5' AT THE ROW
- 4. CLEANOUTS SHALL BE REQUIRED AT THE FOLLOWING LOCATIONS: -APPROXIMATELY 2' FROM THE BUILDING AT THE CHANGE FROM BUILDING DRAIN TO SIDE SEWER.
  - -EVERY 135 DEGREES OF TOTAL BEND (INCLUDING HORZ. AND VERT.).
  - -EVERY 100' OF PIPE RUN.
  - -EVERY CHANGE OF PIPE SIZE
- -AT THE PROPERTY LINE.
- 5. PIPE SHALL HAVE MINIMUM DEPTH OF COVER OF 3' IN DRIVING AREAS.

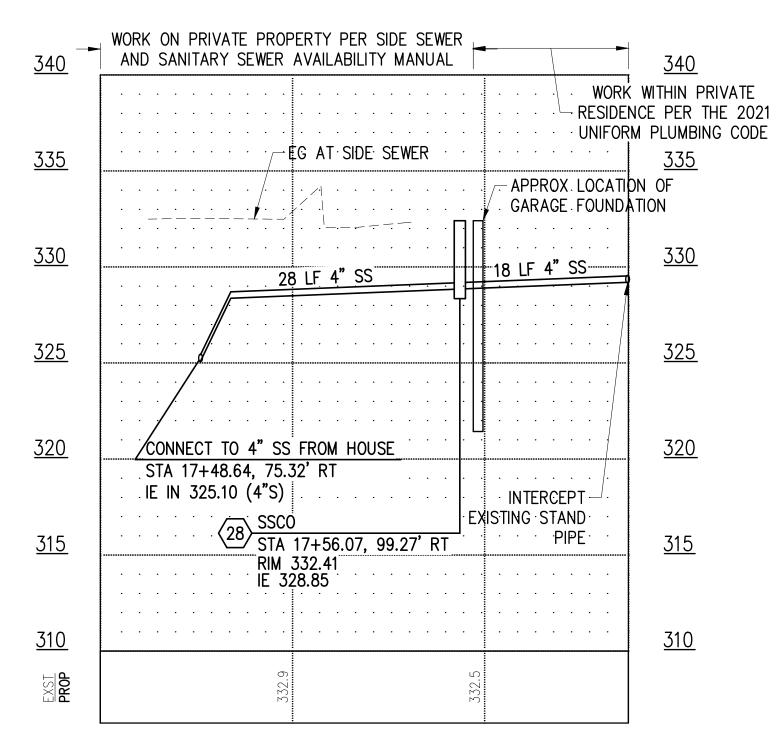

#### **SIDE SEWER PROFILE #2** HOR: 1"=10' VER: 1"-5'

CALL 2 DAYS **BEFORE YOU DIG** 1-800-424-5555


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Tacoma, WA 98402 253.627.0720 Seattle | Wenatchee | **KPG.com** 



					FINAL CONSTRUCTION CHECKED	DATE 05/24	SCALE  AS NOTE
CHI					BY	DESIGNED EH	CHECKED NIM
					DATE	DRAWN <b>EH</b>	PROJECT NAME WWSS-MCKIN
<b>KCOMa</b>					FIELD BOOKS	DRAWING NAME	
	ОИ	REVISION	DATE	APPD		ENV-04018-08-05 P	S Side Sewers



CITY OF TACOMA ENVIRONMENTAL SERVICES DEPARTMENT

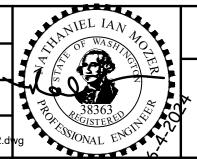**GENERAL NOTES** 

CONSTRUCTION.

SEWER PIPE.

REQUIREMENTS.

1. THE HORIZONTAL AND VERTICAL SIDE SEWER CONFIGURATION SHOWN

APPROVAL OF THE CONSTRUCTION INSPECTOR, ADJUST THE SIDE

CONSTRUCTION METHODS AND CONDITIONS EXPERIENCED DURING

2. ALL EXISTING UTILITY INFORMATION INCLUDING MATERIAL, DEPTH, AND

POTHOLING AND IS SOLELY FOR THE CONTRACTOR'S BENEFIT. INVERT

ESTIMATED BASED ON RECORD DRAWINGS, GIS, OR OTHER DATA AND

ON THIS SHEET IS APPROXIMATE BASED ON THE INFORMATION AVAILABLE DURING DESIGN. THE CONTRACTOR MAY, WITH THE

SEWER ALIGNMENT AS NEEDED TO BETTER ACCOMMODATE

LOCATION ARE BASED ON AVAILABLE INFORMATION WITHOUT

ELEVATIONS FOR UTILITY CROSSINGS SHOWN ON PROFILES ARE

MAY NOT BE ACCURATE. INVERT ELEVATIONS FOR SOME UTILITY

CROSSINGS ARE NOT AVAILABLE; THESE UTILITIES ARE SHOWN ON

THE PROFILES IN THEIR APPROX. HORIZONTAL LOCATION TO ALERI

LOCATIONS SPECIFIED HEREIN A MINIMUM OF 5 WORKING DAYS PRIOR

HORIZONTAL/VERTICAL LOCATION AND MATERIAL. CONTRACTOR SHALL

NOTIFY THE ENGINEER IMMEDIATELY IN THE EVENT OF CONFLICT.

AND FITTINGS REQUIRED TO REALIGN PLUMBING WITHIN EXISTING

EXISTING WATER SERVICE SHALL BE CONSTRUCTED WITH C900 PVC

CONTRACTOR SHALL BE RESPONSIBLE FOR DETERMINING EXISTING PIPE

3. CONTRACTOR SHALL BE RESPONSIBLE FOR DETERMINING ALL PIPE

BASEMENTS/CRAWL SPACES WHERE SPECIFIED ON THE PLANS.

4. SIDE SEWERS WITHIN 10' HORIZONTALLY OR 18" VERTICALLY OF

MATERIALS AND PROVIDING AN APPROPRIATE COUPLING TO

TRANSITION FROM EXISTING TO PROPOSED SIDE SEWER PIPE

6. CONSTRUCTION MAY REQUIRE EXCAVATION WITHIN 10 FEET OF UTILITY

POLES. WHERE ANTICIPATED, CONTRACTOR SHALL CONTACT TACOMA POWER (253) 502-8991 AT LEAST 2 WEEKS IN ADVANCE OF ANY

CONSTRUCTION ACTIVITY WITHIN 10 FEET OF AN EXISTING POLE TO

SPECIAL PROVISION SECTION 1-07.17 FOR ADDITIONAL DETAIL AND

7. CONSTRUCTION WILL REQUIRE EXCAVATION IMMEDIATELY ADJACENT TO

RESPONSIBILITY TO PRESERVE AND PROTECT ALL BUILDINGS AND

CONSTRUCTED IN THE 1920'S. IT IS THE CONTRACTOR'S

8. CONTRACTOR SHALL BE RESPONSIBLE FOR LOCATING EXISTING

1. FINISHED FLOOR ELEVATIONS INTERNAL WITHIN THE HOME SHOWN ON

THE PROFILE ARE BASED ON LIMITED SURVEY AND ARE APPROXIMATE BOTTOM OF FLOOR JOIST ELEVATION IN THE BASEMENT IS UNKNOWN BOTTOM OF FLOOR JOIST ELEVATION IN THE GARAGE IS UNKNOWN CONSTRUCTION OF THIS SIDE SEWER WILL REQUIRE EXCAVATING BELOW

GRADE IN THE BASEMENT. CONTRACTOR SHALL SAWCUT THE CONC.

FLOOR SLAB IN THE BASEMENT PRIOR TO CONC. REMOVAL

LOCATION OF THE CONSTRUCTION AREA.

UTILITIES ON PRIVATE PROPERTY.

EXISTING BUILDING AND STRUCTURES, THE MAJORITY OF WHICH WERE

STRUCTURES AND TO MAKE SURE CONSTRUCTION METHODS, SHORING METHODS, AND COMPACTION METHODS ARE APPROPRIATE GIVEN THE

COORDINATE AN ONSITE VISIT WITH A TPU FIELD INSPECTOR. SEE

5. THE EXISTING SIDE SEWER PIPE MATERIAL(S) IS UNKNOWN.


THE CONTRACTOR OF THEIR EXISTENCE. THE CONTRACTOR SHALL POTHOLE UTILITY CROSSINGS & CONNECTION POINTS AT THE


TO BEGINNING UTILITY IMPROVEMENTS TO VERIFY

WASTEWATER SIDE SEWER IMPROVEMENTS MCKINLEY ROAD SIDE SEWER PLAN + PROFILE & TEMPORARY RESTORATION PLAN 952 MCKINLEY ROAD

ENV-04018-08 PWK-00438-46

ES24-0034F

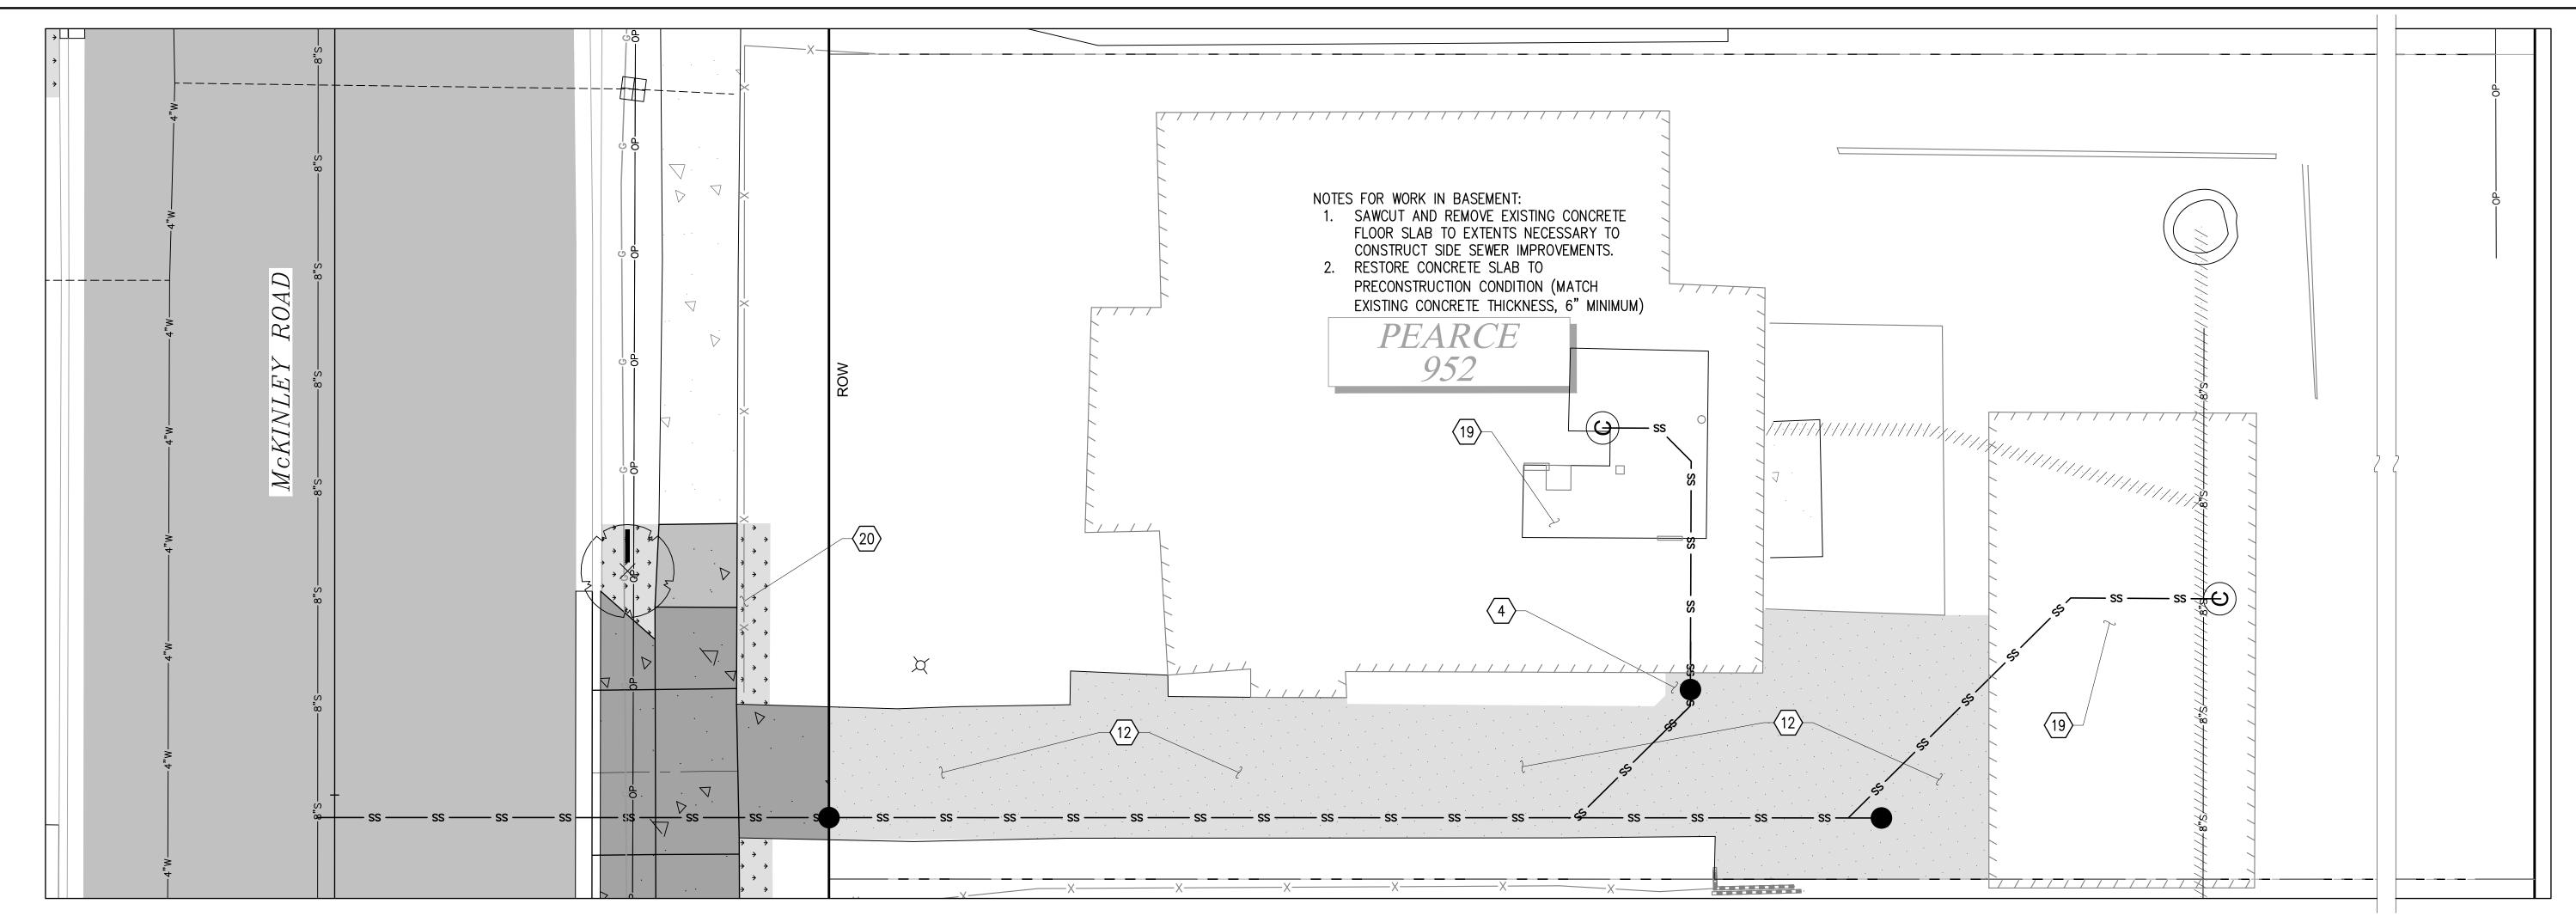

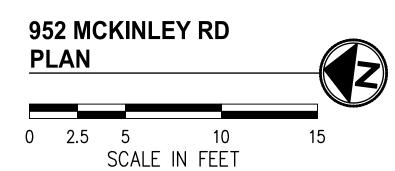



SOFT SURFACE RESTORATION ON PRIVATE PROPERTY, SEE NOTES, THIS SHEET

PLANTER STRIP/LAWN WITHIN ROW

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- 2. FOR RESTORATION WITHIN ROW SEE SHEETS 29-31.

#### **CONSTRUCTION NOTES**

- REINSTALL SALVAGED BRICK PAVERS AT PRECONSTRUCTION LOCATION AND CONDITION OR REPLACE IN-KIND.
- RECONSTRUCT DRIVEWAY APRON AT PRECONSTRUCTION LOCATION PER SECTION B, SHEET 36. APRON RESTORATION EXTENTS SHALL MATCH PRECONSTRUCTION EXTENTS. ADD EXPANSION JOINTS AT 8'
- RESTORE RESIDENCE TO PRECONSTRUCTION CONDITION. REMOVE ALL UNUSED CONSTRUCTION MATERIAL AND DEBRIS.
- REINSTALL SALVAGED CHAIN LINK FENCE IN SAME CONDITION BEHIND PROPOSED SIDEWALK IMPROVEMENTS OR REPLACE IN-KIND.

**CALL 2 DAYS BEFORE YOU DIG** 1-800-424-5555


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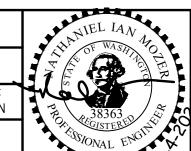
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		FINAL CONSTRUCTION CHECKED	DATE <b>05/24</b>	SCALE 1"=5'	
			DESIGNED	CHECKED	1
		BY	EH	NIM	4
		DATE	DRAWN	PROJECT NAME	1
			EH	WWSS-MCKIN	3
		FIELD BOOKS	DRAWING NAME		
DATE	APPD		952 McKinley Road.	dwg	




CITY OF TACOMA ENVIRONMENTAL SERVICES DEPARTMENT


952 MCKINLEY ROAD


WASTEWATER SIDE SEWER IMPROVEMENTS MCKINLEY ROAD PRIVATE IMPROVEMENT RESTORATION PLAN

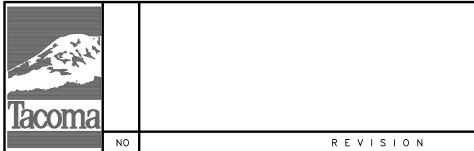ENV-04018-08 PWK-00438-46

ES24-0034F

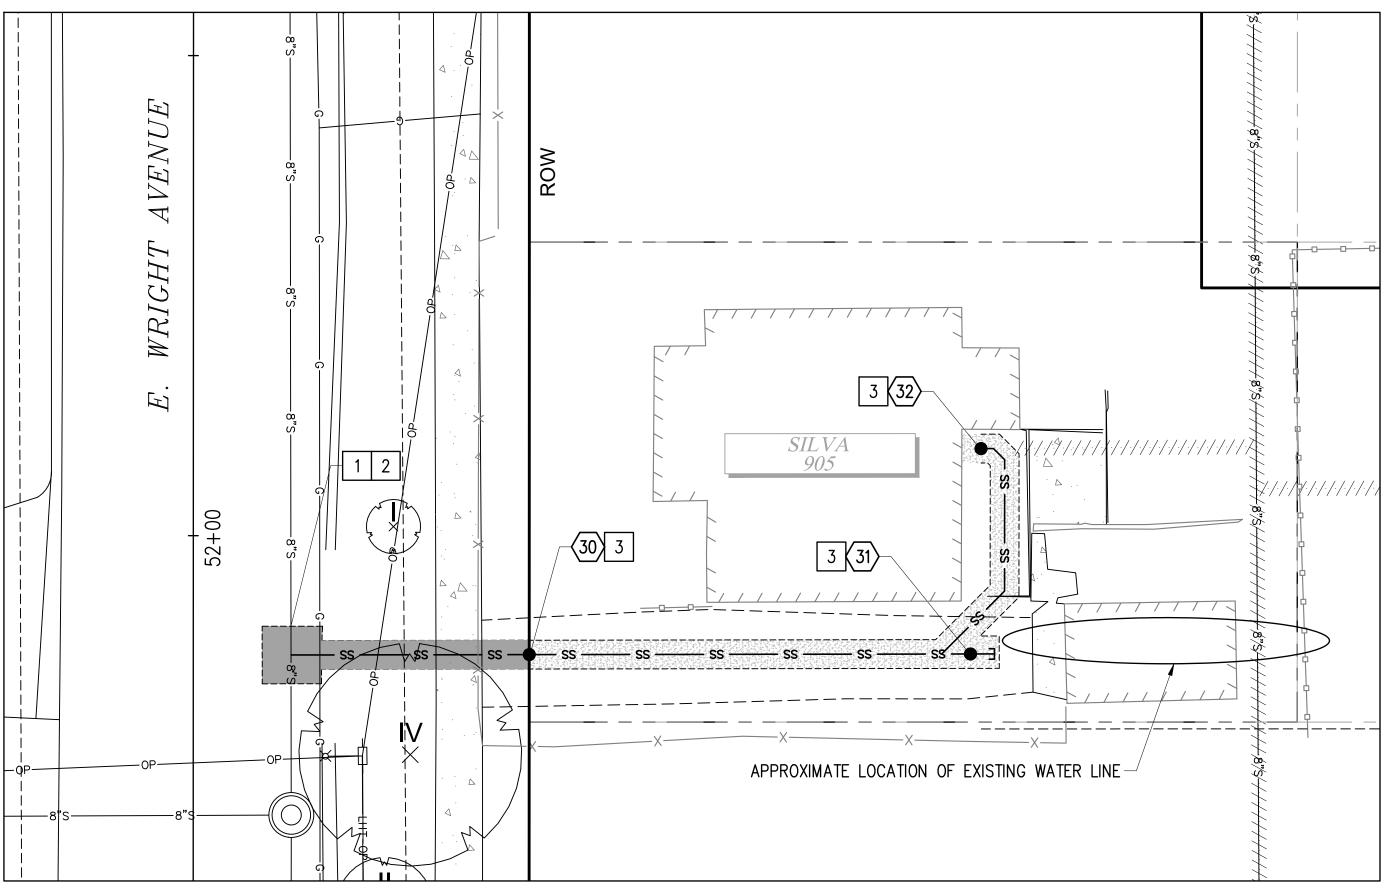

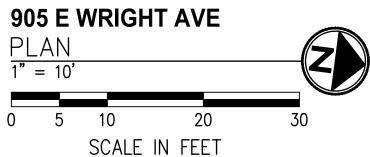

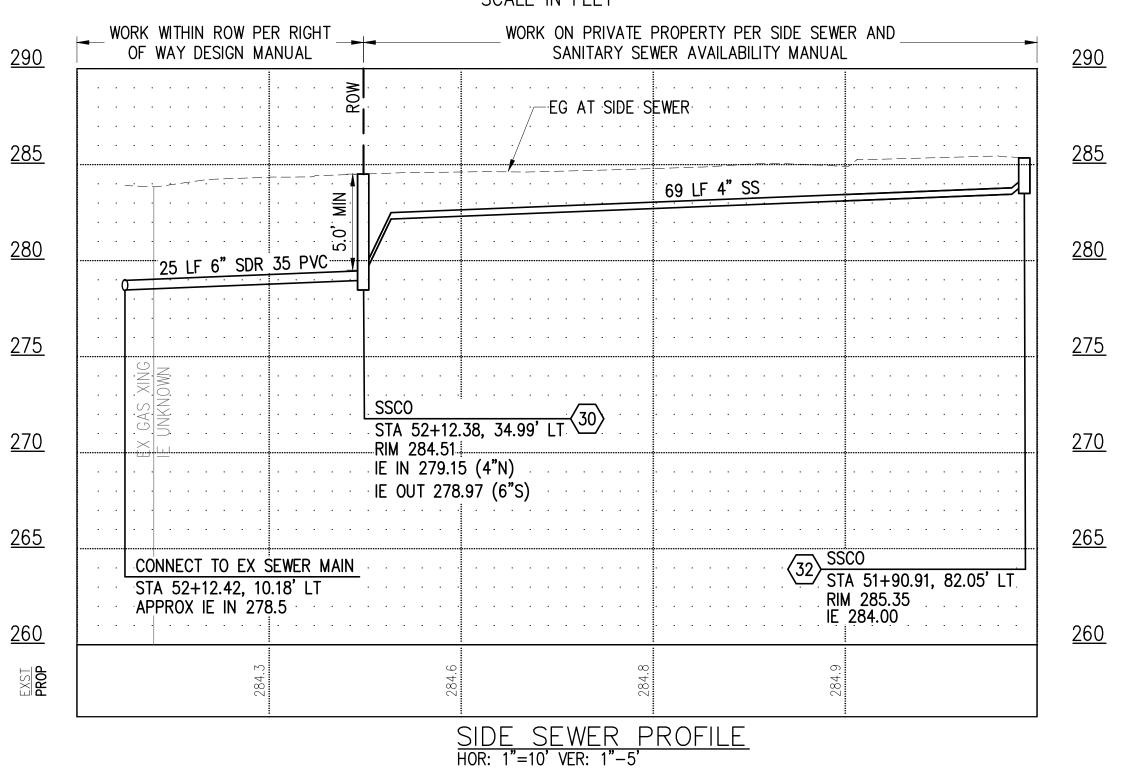

### CALL 2 DAYS **BEFORE YOU DIG** 1-800-424-5555

## BID **DOCUMENT**



Tacoma, WA 98402 253.627.0720

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**CONSTRUCTION NOTES** 

2, SHEET 37

SS CLEANOUT

4" ON PRIVATE PROPERTY.

—— ss —— SIDE SEWER

DETAIL 3, SHEET 37

SS CLEANOUT NUMBER

2. SIDE SEWER MINIMUM PIPE SLOPE IS 2.0%.

BUILDING DRAIN TO SIDE SEWER.

-EVERY 100' OF PIPE RUN.

-AT THE PROPERTY LINE.

-EVERY CHANGE OF PIPE SIZE.

**LEGEND** 

1 CONNECT TO EXISTING SEWER MAIN PER COT STANDARD PLAN SU-23.

2 CONSTRUCT PVC SIDE SEWER PER THE COT SIDE SEWER AND SANITARY SEWER AVAILABILITY MANUAL.

3 CONSTRUCT CLEANOUT PER COT STANDARD PLAN SU-24.

TEMPORARY HMA PATCH PER DETAIL

TEMPORARY CSTC TRENCH PATCH PER

SIDE SEWER CONSTRUCTION STANDARDS

1. PIPE SIZE SHALL BE A MINIMUM OF 6" WITHIN ROW AND MINIMUM OF

3. SIDE SEWERS SHALL HAVE A MINIMUM DEPTH OF 5' AT THE ROW

4. CLEANOUTS SHALL BE REQUIRED AT THE FOLLOWING LOCATIONS:

5. PIPE SHALL HAVE MINIMUM DEPTH OF COVER OF 3' IN DRIVING

-APPROXIMATELY 2' FROM THE BUILDING AT THE CHANGE FROM

-EVERY 135 DEGREES OF TOTAL BEND (INCLUDING HORZ. AND VERT.).

### **GENERAL NOTES**

- 1. THE HORIZONTAL AND VERTICAL SIDE SEWER CONFIGURATION SHOWN ON THIS SHEET IS APPROXIMATE BASED ON THE INFORMATION AVAILABLE DURING DESIGN. THE CONTRACTOR MAY, WITH THE APPROVAL OF THE CONSTRUCTION INSPECTOR, ADJUST THE SIDE SEWER ALIGNMENT AS NEEDED TO BETTER ACCOMMODATE CONSTRUCTION METHODS AND CONDITIONS EXPERIENCED DURING CONSTRUCTION.
- 2. ALL EXISTING UTILITY INFORMATION INCLUDING MATERIAL, DEPTH, AND LOCATION ARE BASED ON AVAILABLE INFORMATION WITHOUT POTHOLING AND IS SOLELY FOR THE CONTRACTOR'S BENEFIT. INVERT ELEVATIONS FOR UTILITY CROSSINGS SHOWN ON PROFILES ARE ESTIMATED BASED ON RECORD DRAWINGS, GIS, OR OTHER DATA AND MAY NOT BE ACCURATE. INVERT ELEVATIONS FOR SOME UTILITY CROSSINGS ARE NOT AVAILABLE; THESE UTILITIES ARE SHOWN ON THE PROFILES IN THEIR APPROX. HORIZONTAL LOCATION TO ALERI THE CONTRACTOR OF THEIR EXISTENCE. THE CONTRACTOR SHALL POTHOLE UTILITY CROSSINGS & CONNECTION POINTS AT THE LOCATIONS SPECIFIED HEREIN A MINIMUM OF 5 WORKING DAYS PRIOR TO BEGINNING UTILITY IMPROVEMENTS TO VERIFY HORIZONTAL/VERTICAL LOCATION AND MATERIAL. CONTRACTOR SHALL NOTIFY THE ENGINEER IMMEDIATELY IN THE EVENT OF CONFLICT.
- 3. CONTRACTOR SHALL BE RESPONSIBLE FOR DETERMINING ALL PIPE AND FITTINGS REQUIRED TO REALIGN PLUMBING WITHIN EXISTING BASEMENTS/CRAWL SPACES WHERE SPECIFIED ON THE PLANS.
- 4. SIDE SEWERS WITHIN 10' HORIZONTALLY OR 18" VERTICALLY OF EXISTING WATER SERVICE SHALL BE CONSTRUCTED WITH C900 PVC SEWER PIPE.
- 5. THE EXISTING SIDE SEWER PIPE MATERIAL(S) IS UNKNOWN. CONTRACTOR SHALL BE RESPONSIBLE FOR DETERMINING EXISTING PIPE MATERIALS AND PROVIDING AN APPROPRIATE COUPLING TO TRANSITION FROM EXISTING TO PROPOSED SIDE SEWER PIPE
- 6. CONSTRUCTION MAY REQUIRE EXCAVATION WITHIN 10 FEET OF UTILITY POLES. WHERE ANTICIPATED, CONTRACTOR SHALL CONTACT TACOMA POWER (253) 502-8991 AT LEAST 2 WEEKS IN ADVANCE OF ANY CONSTRUCTION ACTIVITY WITHIN 10 FEET OF AN EXISTING POLE TO COORDINATE AN ONSITE VISIT WITH A TPU FIELD INSPECTOR. SEE SPECIAL PROVISION SECTION 1-07.17 FOR ADDITIONAL DETAIL AND REQUIREMENTS.
- 7. CONSTRUCTION WILL REQUIRE EXCAVATION IMMEDIATELY ADJACENT TO EXISTING BUILDING AND STRUCTURES, THE MAJORITY OF WHICH WERE CONSTRUCTED IN THE 1920'S. IT IS THE CONTRACTOR'S RESPONSIBILITY TO PRESERVE AND PROTECT ALL BUILDINGS AND STRUCTURES AND TO MAKE SURE CONSTRUCTION METHODS, SHORING METHODS, AND COMPACTION METHODS ARE APPROPRIATE GIVEN THE LOCATION OF THE CONSTRUCTION AREA.
- 8. CONTRACTOR SHALL BE RESPONSIBLE FOR LOCATING EXISTING UTILITIES ON PRIVATE PROPERTY.


CITY OF TACOMA ENVIRONMENTAL SERVICES DEPARTMENT


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WASTEWATER SIDE SEWER IMPROVEMENTS MCKINLEY ROAD SIDE SEWER PLAN + PROFILE & TEMPORARY RESTORATION PLAN 905 E WRIGHT AVENUE

27 <sub>OF</sub> 37

PWK-00438-46



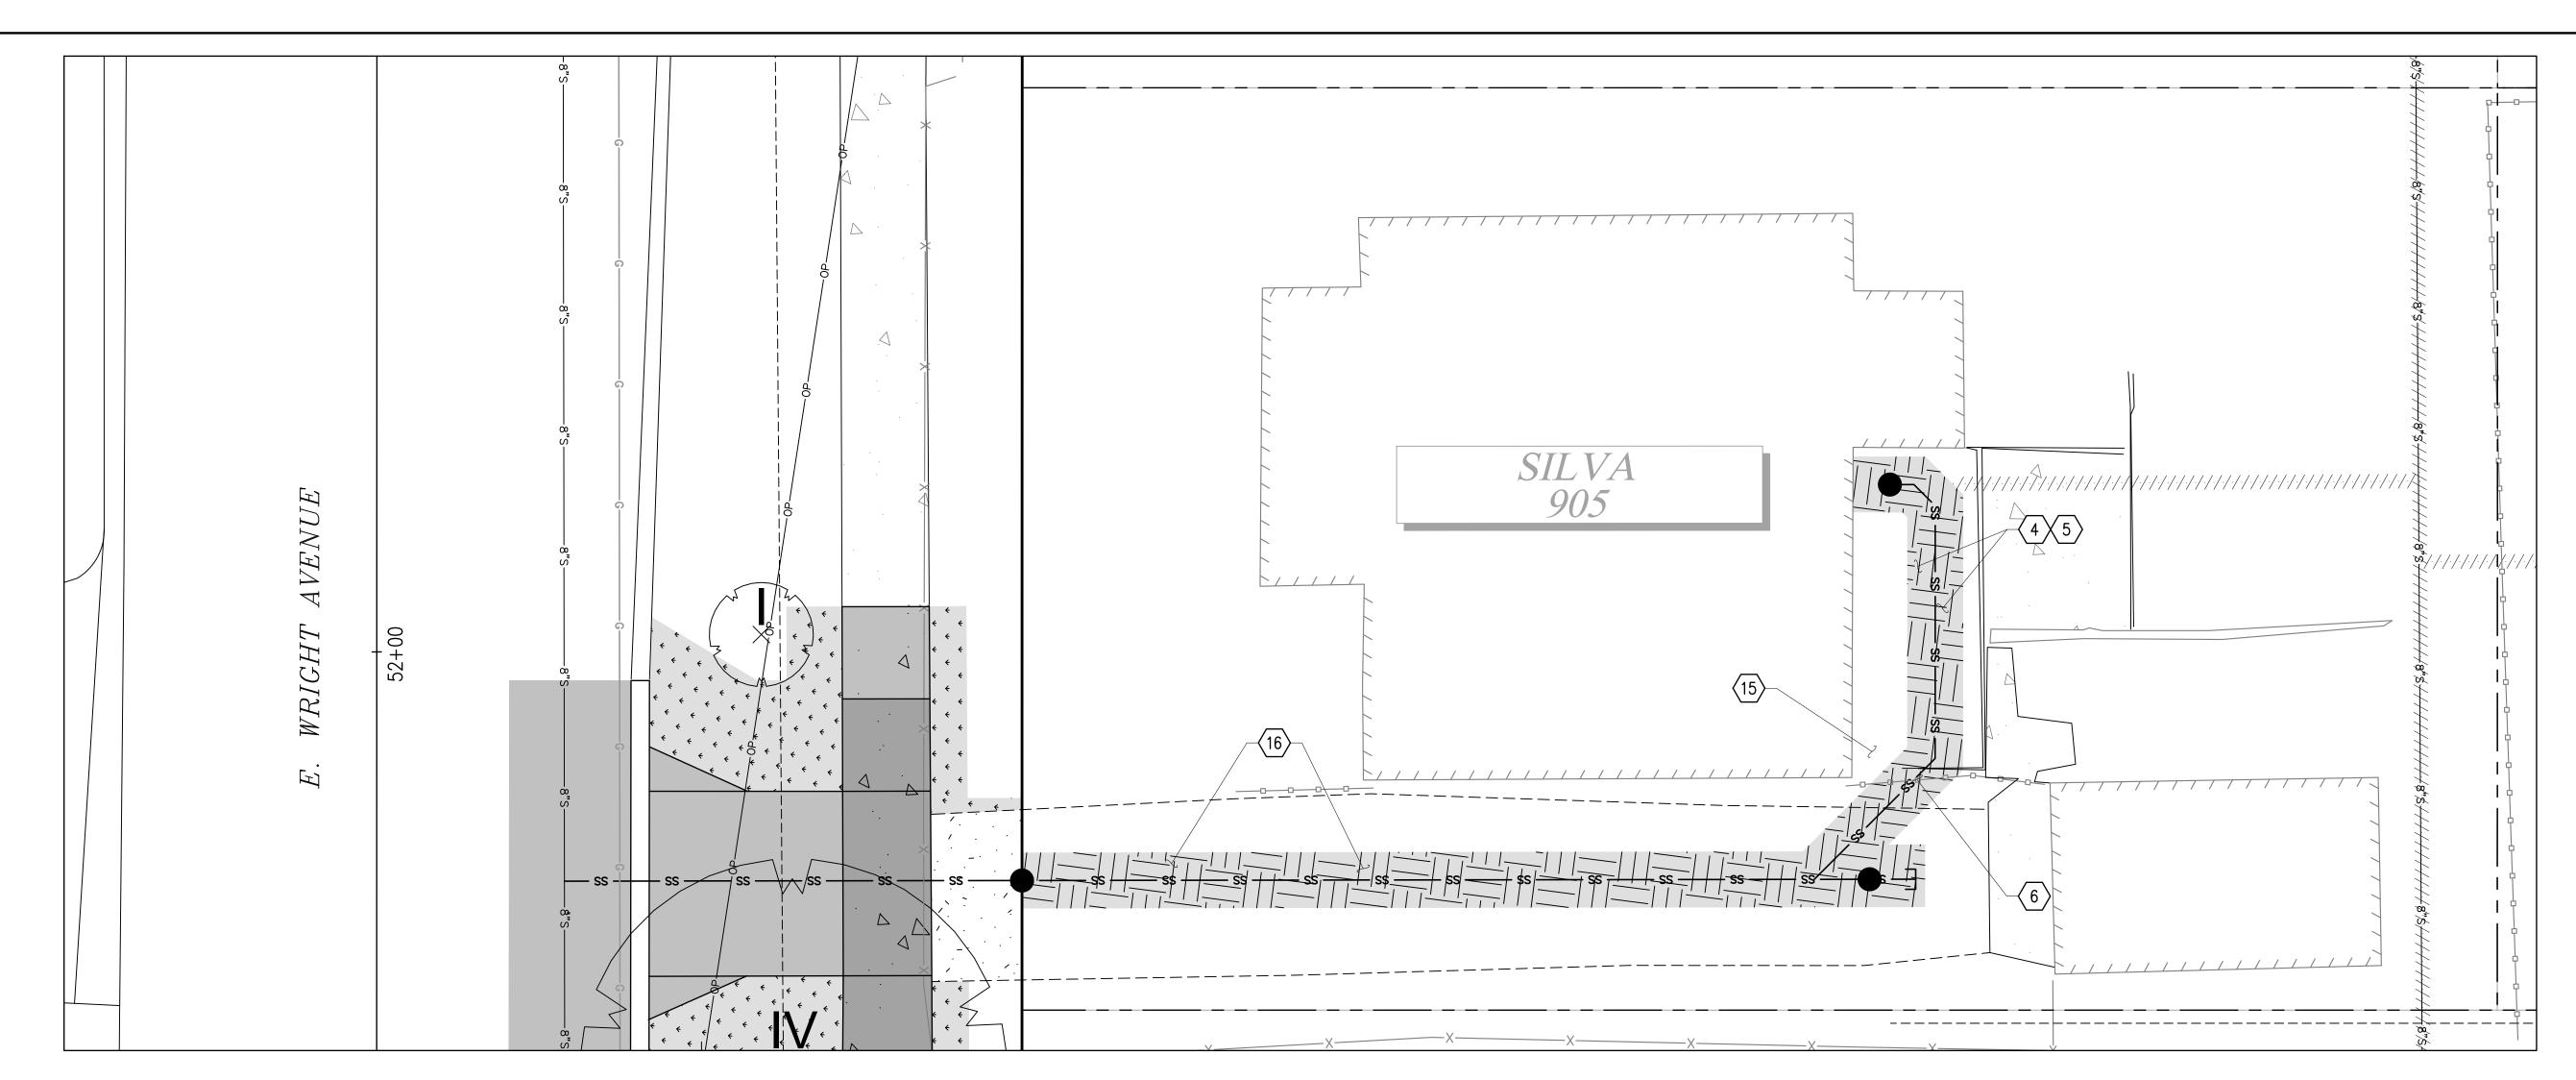

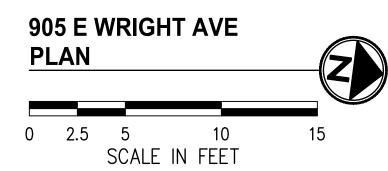HARD SURFACE RESTORATION ON PRIVATE PROPERTY, SEE NOTES, THIS SHEET

SOFT SURFACE RESTORATION ON PRIVATE PROPERTY, SEE NOTES, THIS SHEET

PLANTER STRIP/LAWN WITHIN ROW

#### **GENERAL NOTES**

1. CONTRACTOR SHALL COORDINATE DIRECTLY WITH PROPERTY OWNER AND CITY INSPECTOR TO CONFIRM THE LOCATIONS AND TYPES OF MATERIALS TO USE DURING RESTORATION PRIOR TO BEGINNING THE WORK.

05/24

EH

EH

2. FOR RESTORATION WITHIN ROW SEE SHEETS 29-31.

### **CONSTRUCTION NOTES**

- REINSTALL SALVAGED BRICK PAVERS AT PRECONSTRUCTION LOCATION AND CONDITION OR REPLACE IN-KIND.
- REINSTALL SALVAGED LANDSCAPE BORDER AT PRECONSTRUCTION LOCATION AND CONDITION OR REPLACE IN-KIND.
- REINSTALL SALVAGED WOOD FENCE & GATE AT PRECONSTRUCTION LOCATION AND CONDITION OR REPLACE IN-KIND.
- REINSTALL SALVAGED WOODEN STEPS AT PRECONSTRUCTION LOCATION OR REPLACE IN-KIND.
- (16) RESTORE GRAVEL DRIVEWAY PER RESTORATION TABLE, SHEET 35.


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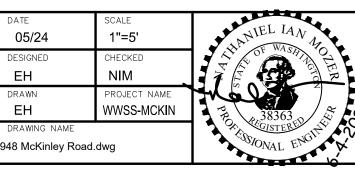


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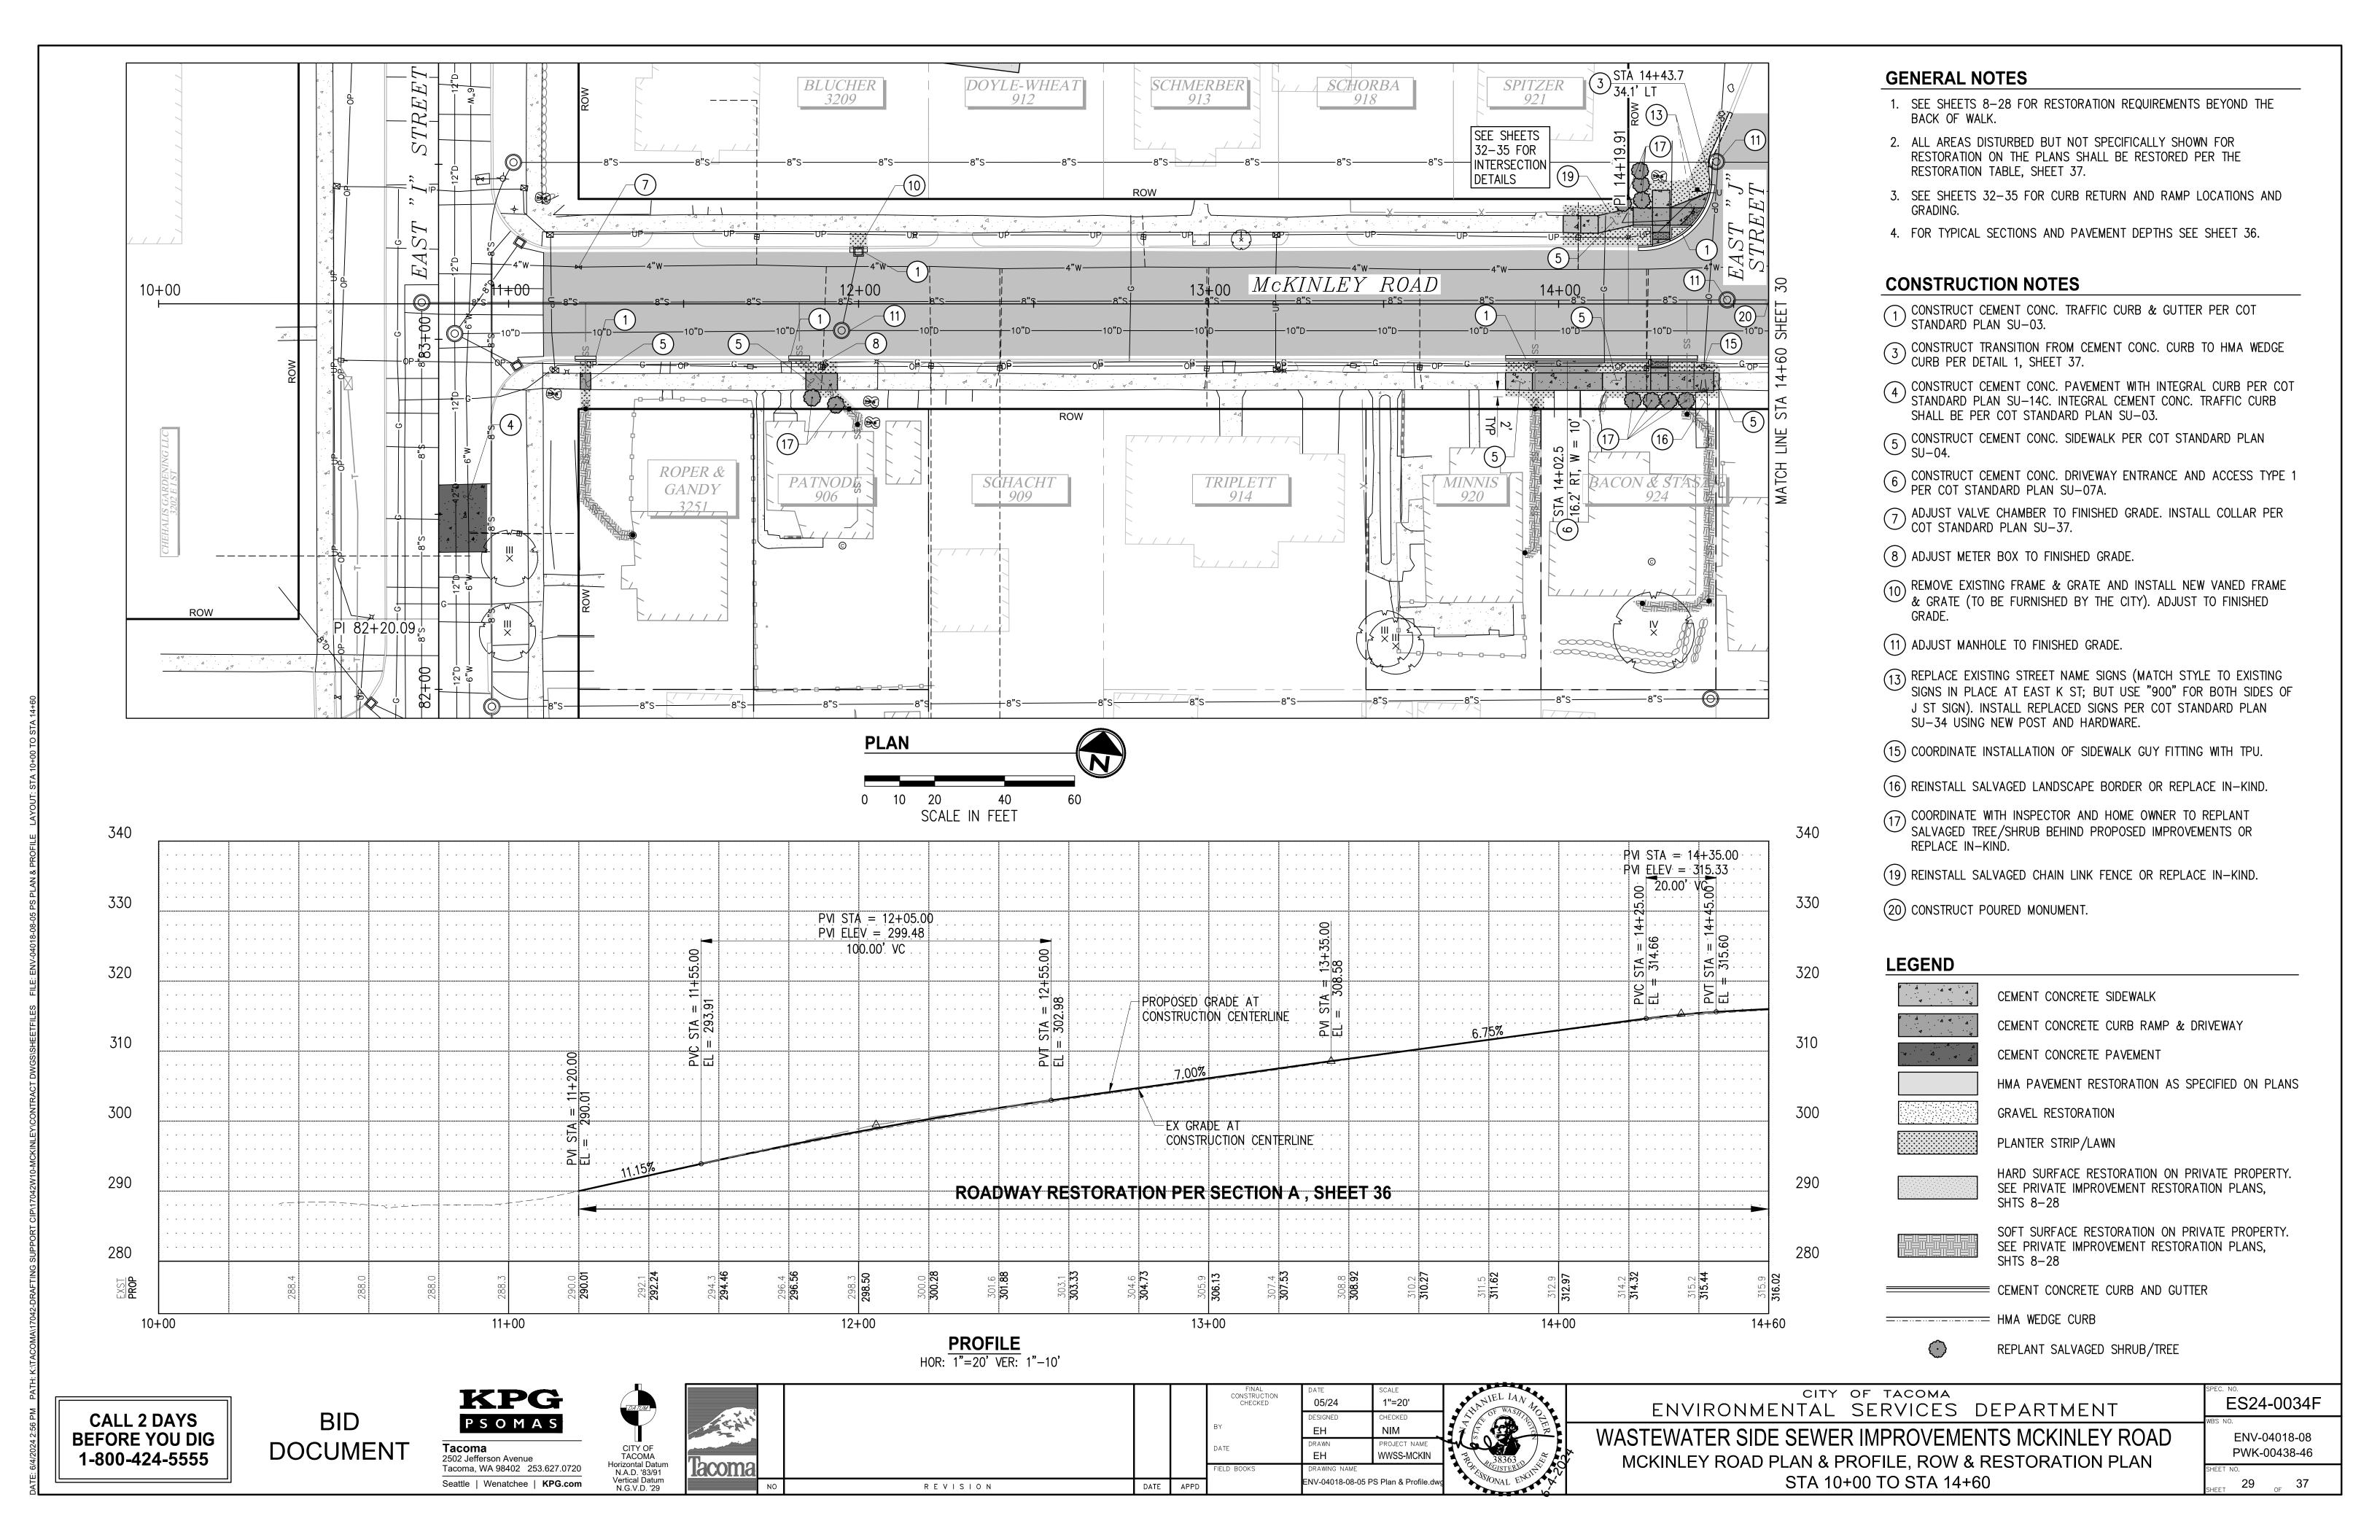






WASTEWATER SIDE SEWER IMPROVEMENTS MCKINLEY ROAD PRIVATE IMPROVEMENT RESTORATION PLAN 905 E WRIGHT AVENUE

ENV-04018-08 PWK-00438-46

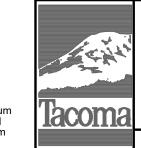ES24-0034F



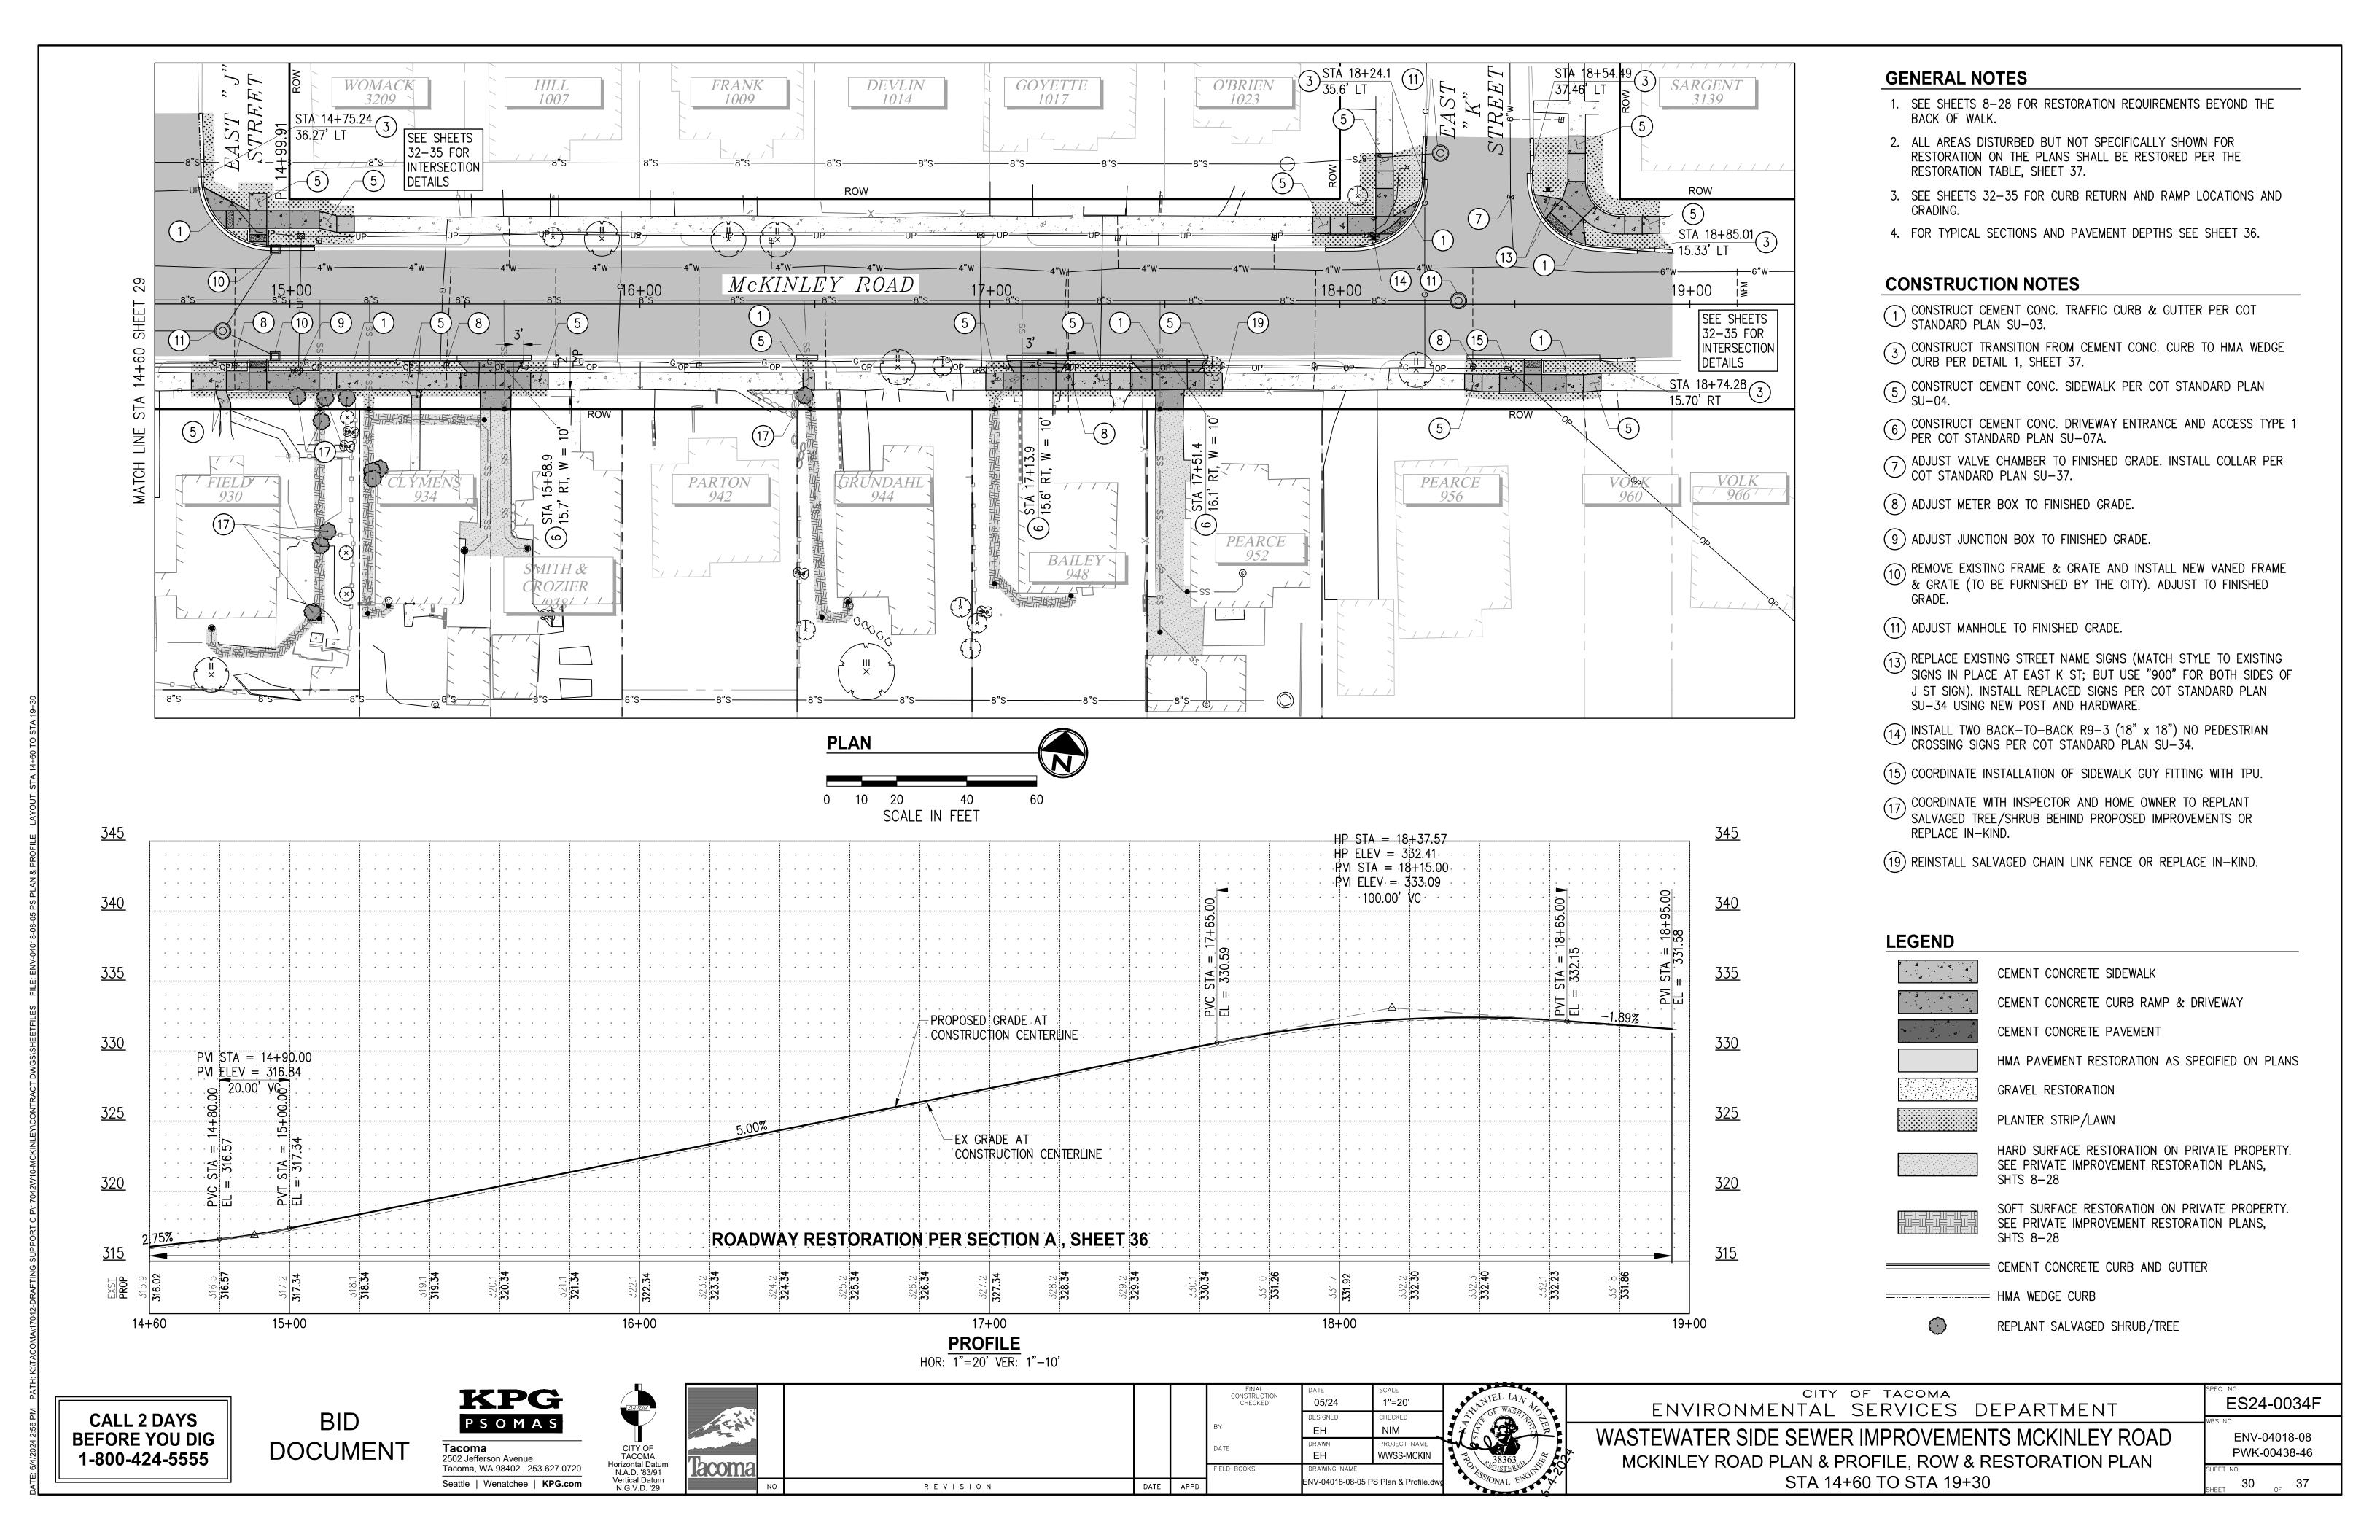

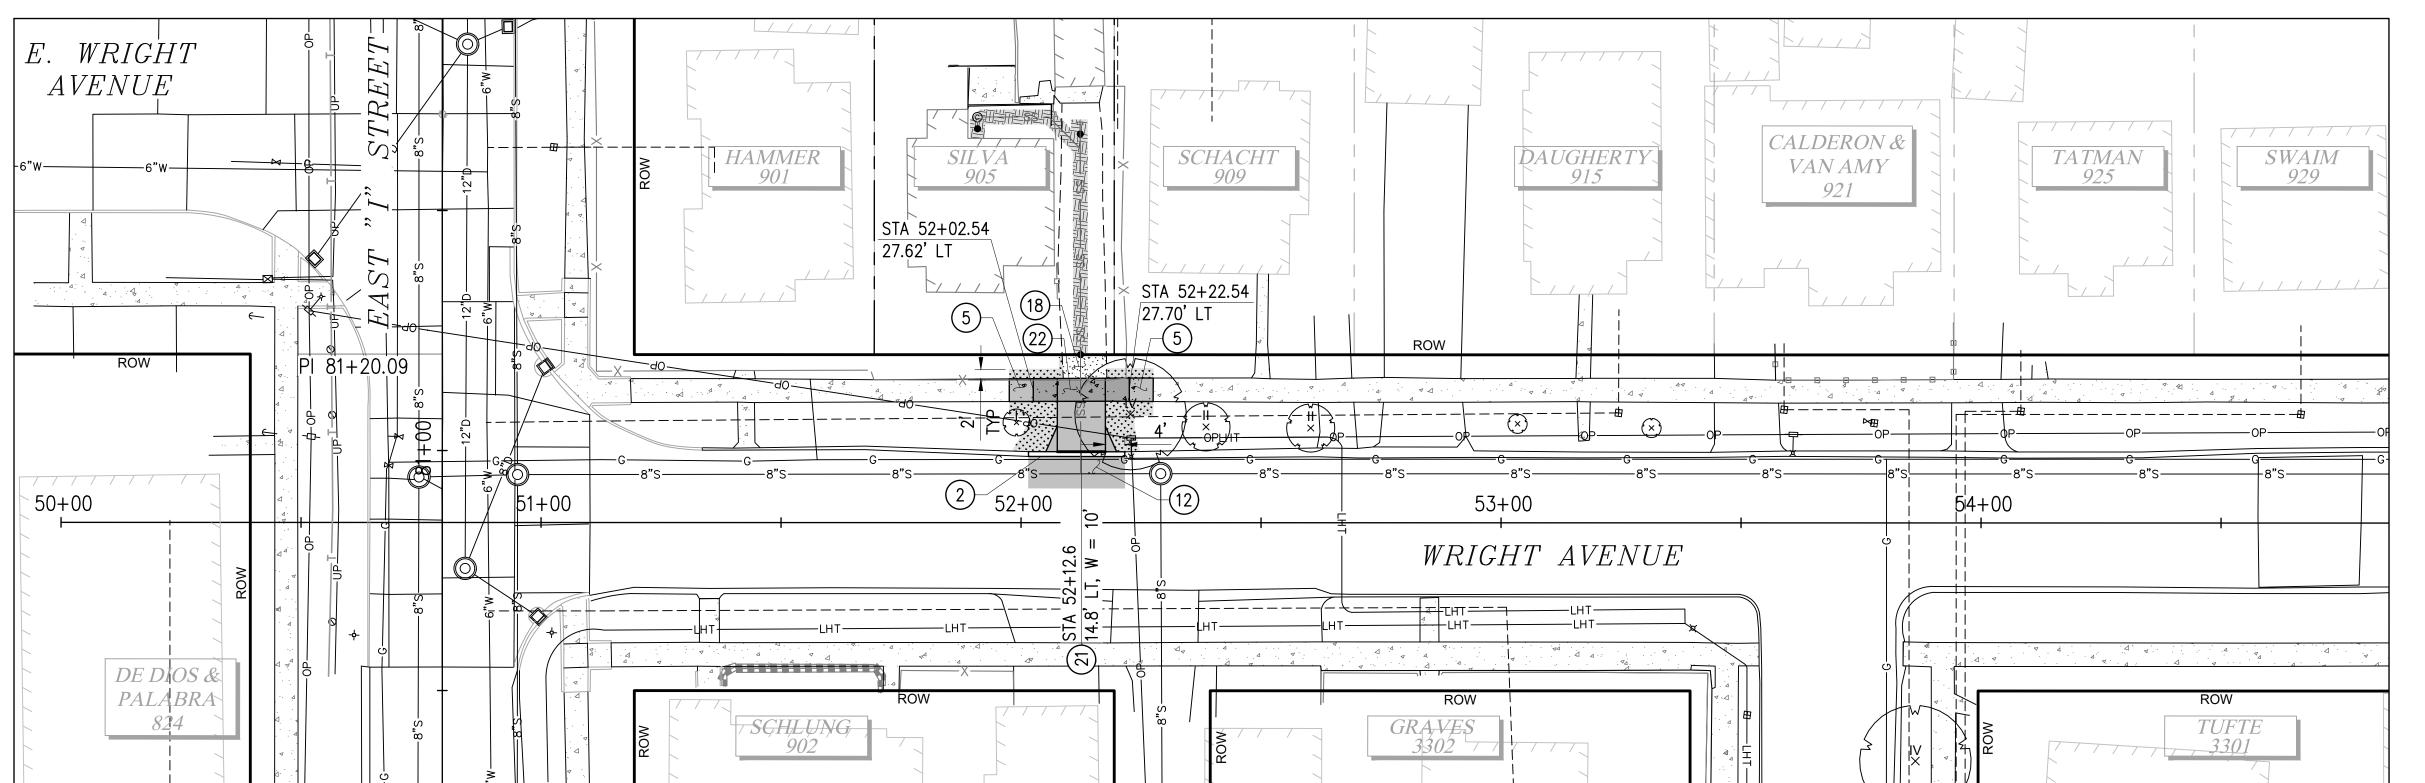

SCALE IN FEET

**PLAN** 

#### **GENERAL NOTES**

- 1. SEE SHEETS 8-28 FOR RESTORATION REQUIREMENTS BEYOND THE BACK OF WALK.
- 2. ALL AREAS DISTURBED BUT NOT SPECIFICALLY SHOWN FOR RESTORATION ON THE PLANS SHALL BE RESTORED PER THE RESTORATION TABLE, SHEET 37.
- 3. SEE SHEETS 32-35 FOR CURB RETURN AND RAMP LOCATIONS AND
- 4. FOR TYPICAL SECTIONS AND PAVEMENT DEPTHS SEE SHEET 36.

#### **CONSTRUCTION NOTES**

- 2 CONSTRUCT STANDARD HMA WEDGE CURB PER COT STANDARD PLAN SU-03A.
- 5 CONSTRUCT CEMENT CONC. SIDEWALK PER COT STANDARD PLAN SU-04.
- CONSTRUCT HMA PAVEMENT RESTORATION PER COT STANDARD PLAN SU-15B.
- (18) RESTORE GRAVEL DRIVEWAY PER RESTORATION TABLE, SHEET 36.
- RECONSTRUCT HMA DRIVEWAY TO PREVIOUS EXTENTS PER SECTION C, SHEET 36.
- CONSTRUCT SIDEWALK WITH 6" CONCRETE DEPTH PER COT STANDARD PLAN SU-07A.

#### **LEGEND**

CEMENT CONCRETE SIDEWALK

CEMENT CONCRETE CURB RAMP & DRIVEWAY

CEMENT CONCRETE PAVEMENT HMA PAVEMENT RESTORATION AS SPECIFIED ON PLANS

GRAVEL RESTORATION

PLANTER STRIP/LAWN

HARD SURFACE RESTORATION ON PRIVATE PROPERTY. SEE PRIVATE IMPROVEMENT RESTORATION PLANS, SHTS 8-28

SOFT SURFACE RESTORATION ON PRIVATE PROPERTY. SEE PRIVATE IMPROVEMENT RESTORATION PLANS, SHTS 8-28

CEMENT CONCRETE CURB AND GUTTER

=----- HMA WEDGE CURB

REPLANT SALVAGED SHRUB/TREE

**CALL 2 DAYS BEFORE YOU DIG** 1-800-424-5555

BID **DOCUMENT** 












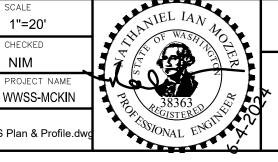

1"=20'




CITY OF TACOMA

STA 50+00 TO STA 54+85

ENV-04018-08 PWK-00438-46

ES24-0034F

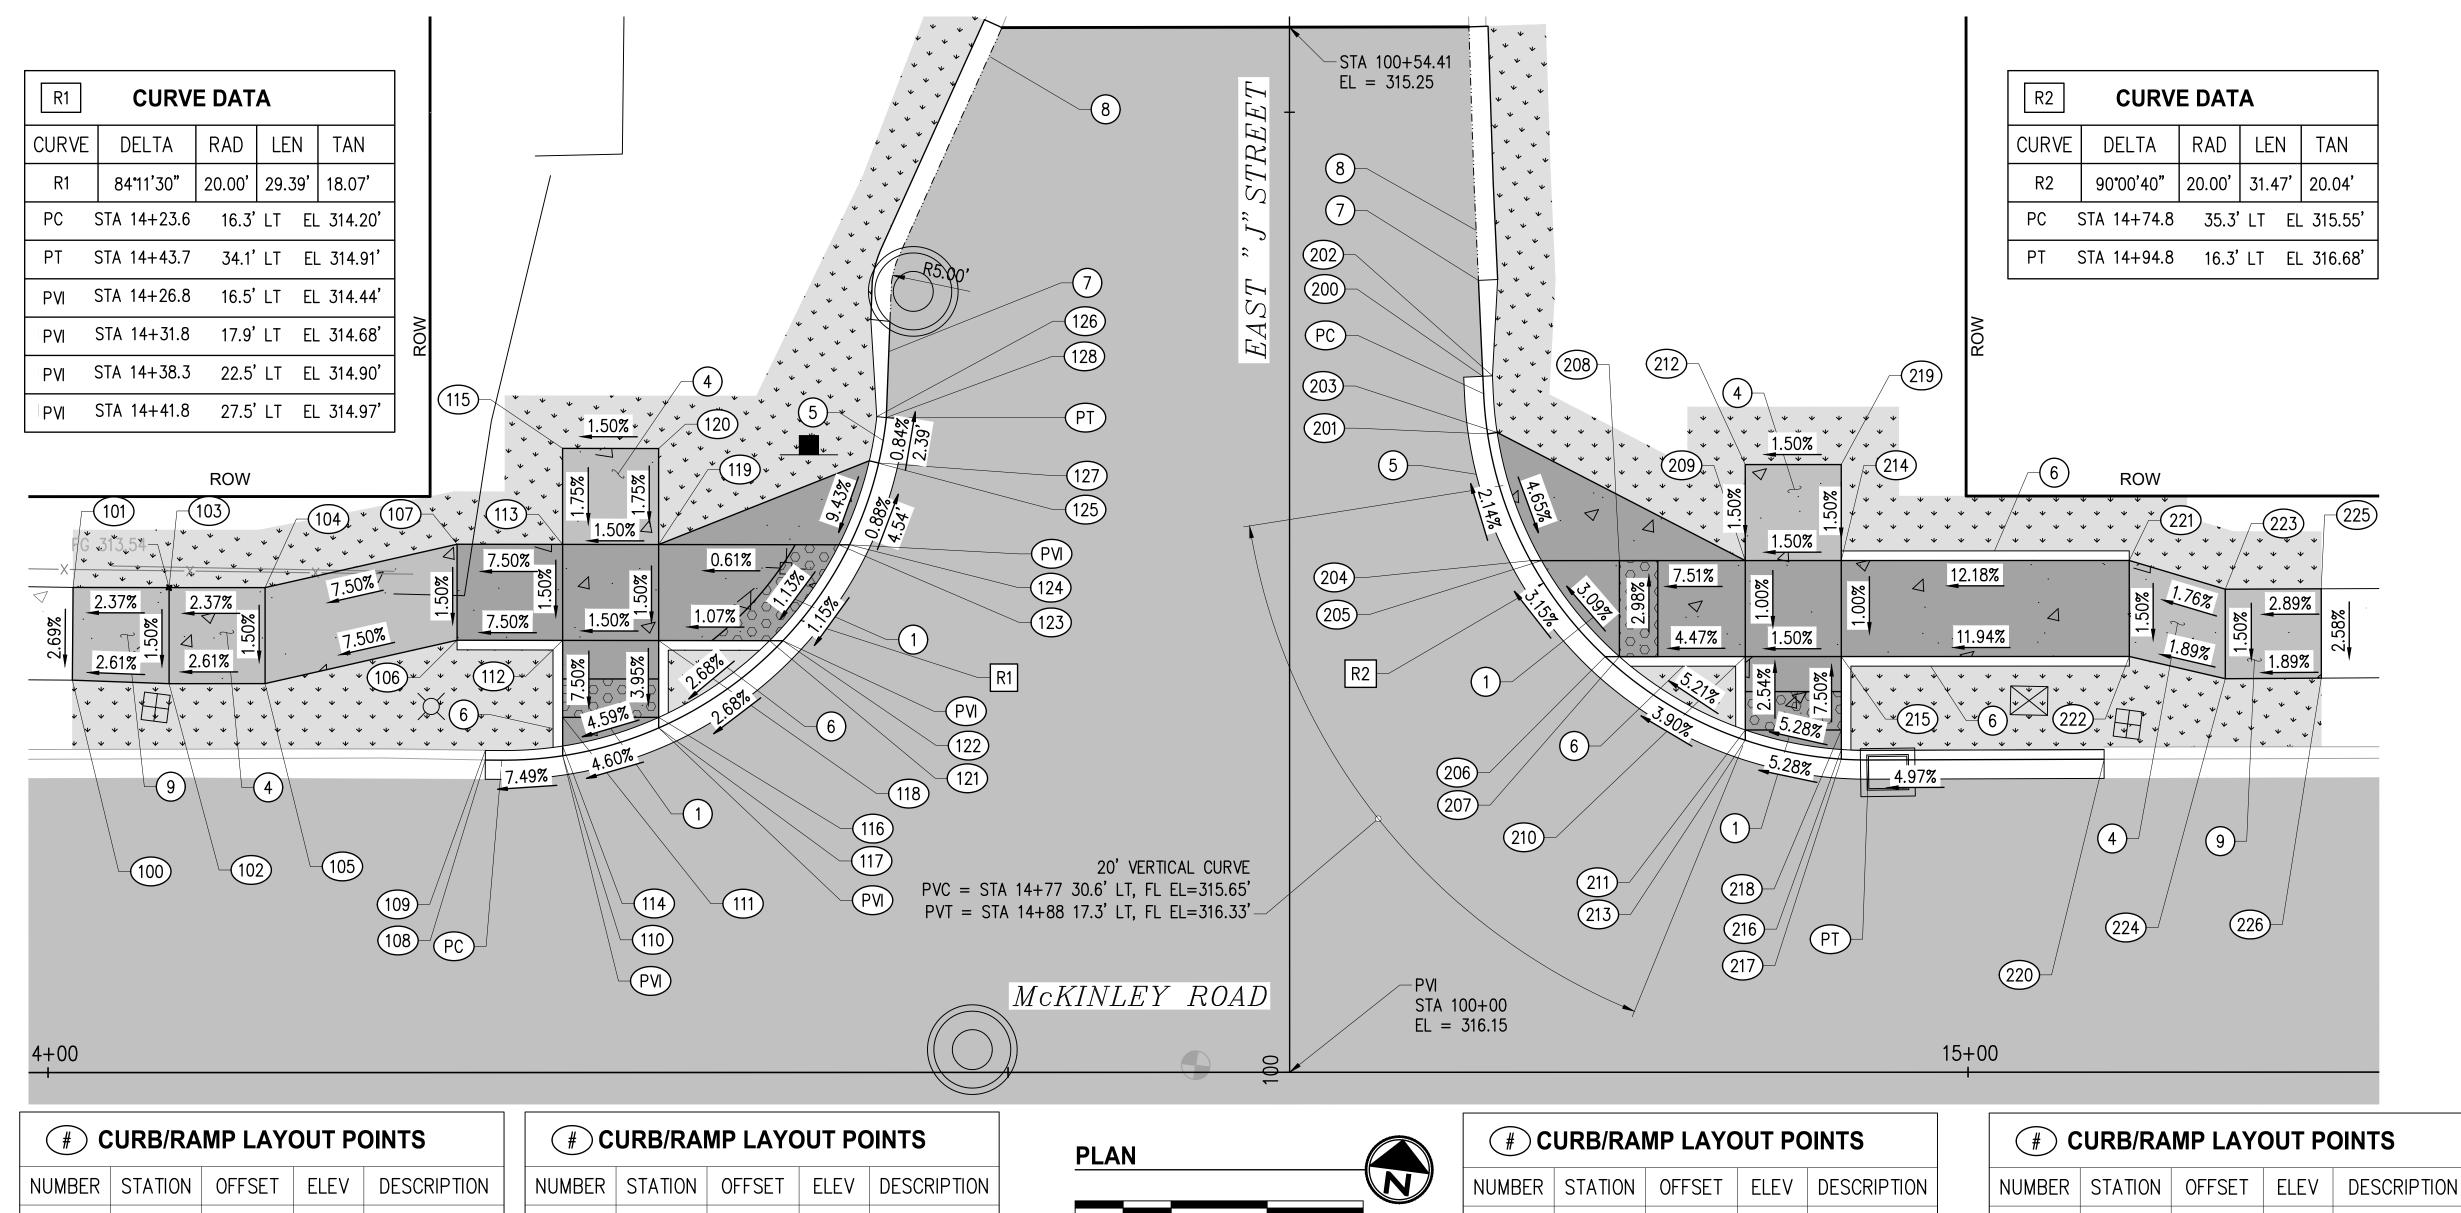

NUMBER	STATION	OFFSET	ELEV	DESCRIPTION
100	14+01.27	20.44' LT	313.32	S/W, MATCH EX
101	14+01.31	25.27' LT	313.42	S/W, MATCH EX
102	14+06.31	20.26' LT	313.45	S/W
103	14+06.31	25.26' LT	313.54	S/W
104	14+11.31	25.26' LT	313.66	S/W
105	14+11.31	20.26' LT	313.58	S/W
106	14+21.31	22.51' LT	314.35	RAMP
107	14+21.31	27.51' LT	314.43	RAMP
108	14+22.78	16.27' LT	314.14	FL, MATCH EX
109	14+22.78	16.78' LT	314.55	TBC, MATCH EX
110	14+26.81	16.50' LT	314.44	RAMP, FL
111	14+26.81	18.49' LT	314.46	RAMP
112	14+26.81	22.50' LT	314.76	RAMP
113	14+26.81	27.50' LT	314.84	RAMP

14+26.81 | 17.00' LT | 314.44

	OIND/INAI	NAMIF LATOUT FOINTS				
NUMBER	STATION	OFFSET	ELEV	DESCRIPTION		
115	14+26.81	32.50' LT	314.93	S/W		
116	14+31.81	18.49' LT	314.68	RAMP		
117	14+31.81	17.94' LT	314.68	RAMP, FL		
118	14+31.81	22.49' LT	314.84	RAMP		
119	14+31.81	27.50' LT	314.91	RAMP		
120	14+31.81	32.49' LT	315.00	S/W		
121	14+37.58	22.48' LT	314.90	RAMP		
122	14+38.28	22.48' LT	314.90	RAMP		
123	14+41.19	27.48' LT	314.97	RAMP		
124	14+41.75	27.48' LT	314.97	RAMP, FL		
125	14+42.78	31.85' LT	315.41	RAMP, TBC		
126	14+43.17	34.15' LT	315.39	TBC		
127	14+43.27	31.74' LT	314.93	RAMP, FL		
128	14+43.67	34.11' LT	314.91	FL		

# 0 2.5 5 SCALE IN FEET

NUMBER	STATION	OFFSET	ELEV	DESCRIPTION
200	14+74.74	36.25' LT	315.53	FL
201	14+74.99	33.24' LT	315.59	RAMP, FL
202	14+75.24	36.27' LT	316.01	TBC
203	14+75.48	33.32' LT	316.07	RAMP,TBC
204	14+77.22	26.64' LT	315.74	RAMP, FL
205	14+77.79	26.64' LT	315.74	RAMP
206	14+81.10	21.64' LT	315.94	RAMP, FL
207	14+81.85	21.64' LT	315.94	RAMP
208	14+81.85	26.64' LT	315.79	RAMP
209	14+88.40	26.64' LT	316.28	RAMP
210	14+88.40	21.64' LT	316.23	RAMP
211	14+88.40	17.82' LT	316.33	RAMP
212	14+88.40	31.64' LT	316.36	S/W
213	14+88.40	17.30' LT	316.33	RAMP, FL

# 0	URB/RA	WP LAY	JUIP	) I N I S
NUMBER	STATION	OFFSET	ELEV	DESCRIPTION
214	14+93.40	26.64' LT	316.36	RAMP
215	14+93.40	21.64' LT	316.31	RAMP
216	14+93.40	16.80' LT	316.60	RAMP
217	14+93.40	16.30' LT	316.60	RAMP, FL
218	14+93.40	17.82' LT	316.59	RAMP
219	14+93.40	31.64' LT	316.43	S/W
220	15+07.09	16.30' LT	317.29	FL, MATCH EX
221	15+08.40	26.65' LT	318.17	RAMP
222	15+08.40	21.65' LT	318.10	RAMP
223	15+13.40	25.15' LT	318.27	S/W
224	15+13.40	20.49' LT	318.20	S/W
225	15+18.40	25.17' LT	318.41	S/W, MATCH EX
226	15+18.40	20.52' LT	318.29	S/W, MATCH EX

#### **GENERAL NOTES**

- 1. PLANTER/BACK OF WALK RESTORATION SHALL BE PER RESTORATION TABLE, SHEET 37.
- 2. ALL LOCATION & ELEVATION CALLOUTS ARE TO FINISHED SIDEWALK/RAMP GRADE UNLESS OTHERWISE NOTED.
- 3. VERTICAL INFLECTION POINTS ALONG THE CURB LINE SHALL BE CLEAR OF THE RAMP BOTTOM.
- 4. DETECTABLE WARNING SURFACES LOCATED ON A RADIUS SHALL BE INSTALLED USING DETECTABLE WARNING TILES MANUFACTURED SPECIFICALLY TO BE INSTALLED ON THE SPECIFIED RADIUS.

#### **CONSTRUCTION NOTES**

- 1 INSTALL COMBINATION CURB RAMP PER COT STANDARD PLAN SU-05C.
- (4) INSTALL CEMENT CONC. SIDEWALK PER COT STANDARD PLAN SU-04.
- 5 INSTALL CEMENT CONC. CURB & GUTTER PER COT STANDARD PLAN SU-03. MODIFY DIMENSIONS AS NECESSARY TO MATCH EXISTING CURB & GUTTER.
- (6) CEMENT CONC. PEDESTRIAN CURB PER COT STD PLAN SU-03A.
- 7 INSTALL HMA WEDGE CURB TRANSITION PER DETAIL 1, SHEET 37. MODIFY DIMENSIONS AS NECESSARY TO MATCH EXISTING HMA WEDGE
- NSTALL HMA WEDGE CURB PER COT STANDARD PLAN SU-03A. (8) MODIFY DIMENSIONS AS NECESSARY TO MATCH EXISTING HMA WEDGE CURB WIDTH.
- 9 TRANSITION PANEL TO MATCH EXISTING SIDEWALK WIDTH AND SLOPE. MAY NOT COMPLY WITH ADA STANDARDS.

#### I FGFND

LLGLIND	
	CEMENT CONCRETE SIDEWALK
	CEMENT CONCRETE CURB RAMP & DRIVEWAY
ψ ψ ψ ψ ψ ψ ψ ψ	PLANTER STRIP / LAWN
	DETECTABLE WARNING SURFACE, PLACE AT GRADE BREAK AND INSTALL PER COT STANDARD PLAN SU-05G
	CEMENT CONCRETE CURB AND GUTTER
	HMA WEDGE CURB

#### ABBREVIATIONS:

FLOWLINE SIDEWALK S/W TOP OF CURB TBC

CALL 2 DAYS **BEFORE YOU DIG** 1-800-424-5555

BID **DOCUMENT** 


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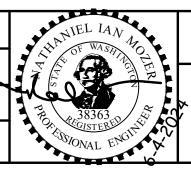


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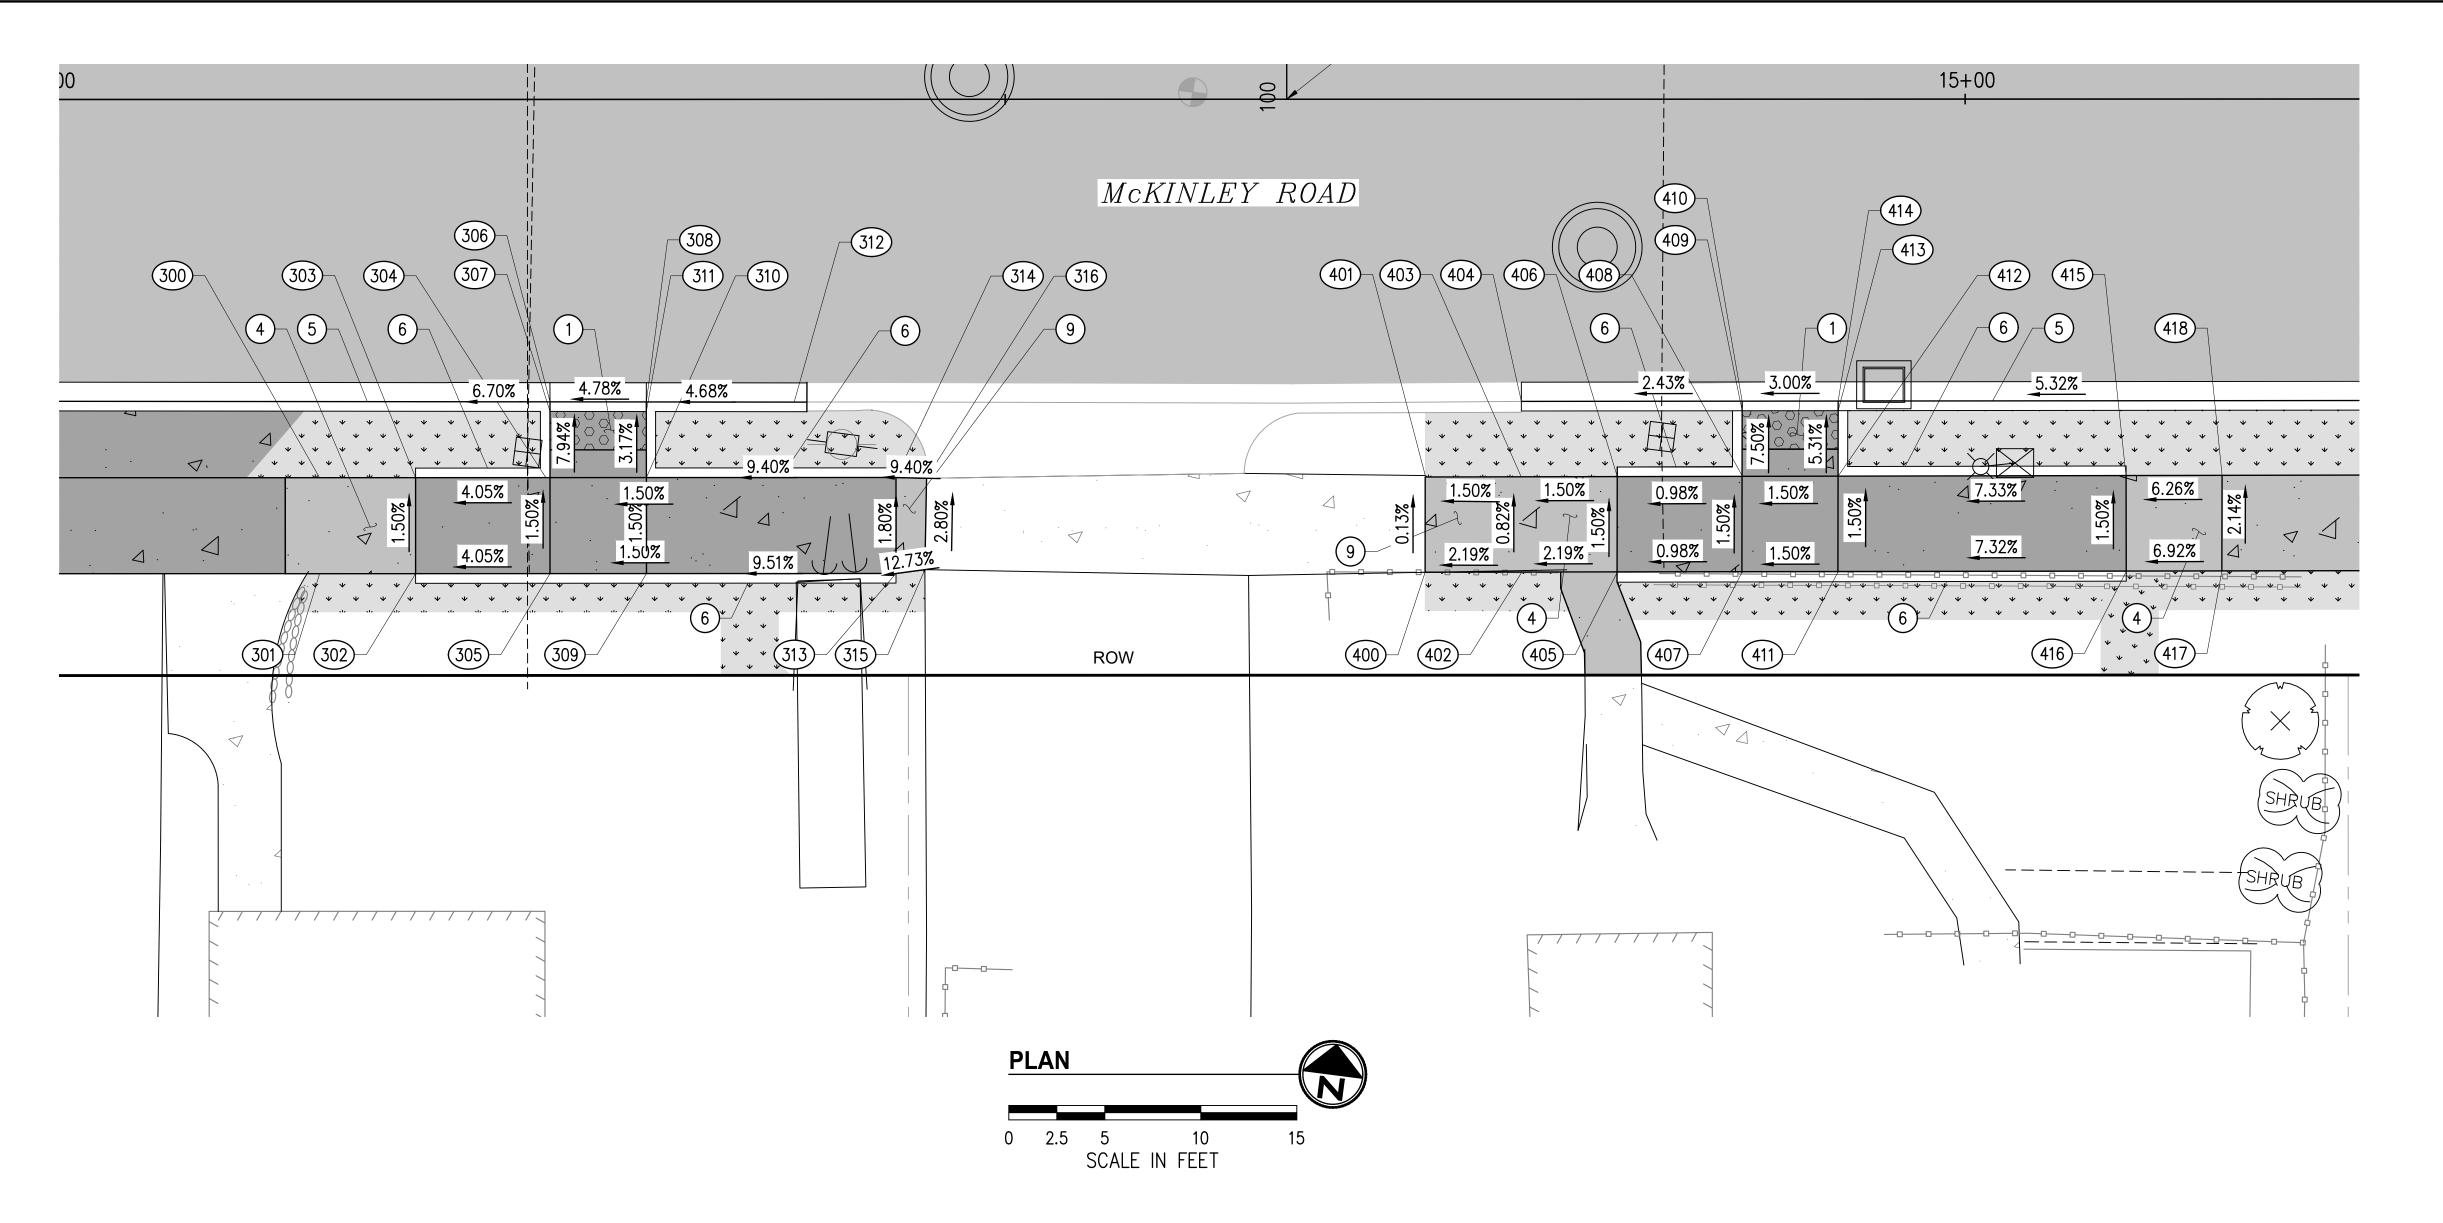




WASTEWATER SIDE SEWER IMPROVEMENTS MCKINLEY ROAD CURB RAMP & INTERSECTION GRADING PLAN MCKINLEY ROAD & EAST J STREET (NORTH)

ENV-04018-08 PWK-00438-46

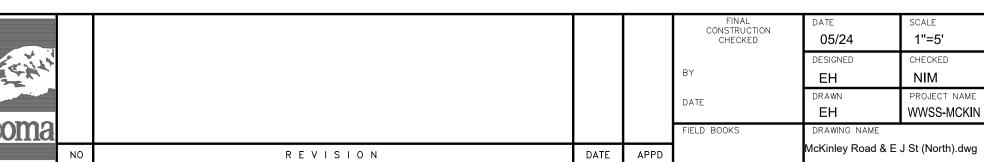ES24-0034F



# CURB/RAMP LAYOUT POINTS						
NUMBER	STATION	OFFSET	ELEV	DESCRIPTION		
300	14+14.29	19.70' RT	314.00	S/W, MATCH EX		
301	14+14.29	24.70' RT	314.07	S/W, MATCH EX		
302	14+19.29	24.70' RT	314.37	RAMP		
303	14+19.29	19.70' RT	314.29	RAMP		
304	14+26.05	19.67' RT	314.56	RAMP		
305	14+26.29	24.70' RT	314.65	RAMP		
306	14+26.29	15.75' RT	314.30	RAMP, FL, PVI		
307	14+26.29	16.25' RT	314.30	RAMP		
308	14+31.31	15.76' RT	314.54	RAMP, FL		
309	14+31.31	24.70' RT	314.72	RAMP		

# 0	# CURB/RAMP LAYOUT POINTS					
NUMBER	STATION	OFFSET	ELEV	DESCRIPTION		
310	14+31.31	19.70' RT	314.65	RAMP		
311	14+31.31	16.26'RT	314.54	RAMP		
312	14+39.01	15.76' RT	314.90	FL, MATCH EX		
313	14+44.31	24.69' RT	315.96	RAMP		
314	14+44.31	19.69'RT	315.87	RAMP		
315	14+45.81	24.49' RT	316.15	S/W, MATCH EX		
316	14+45.90	19.73' RT	316.02	S/W, MATCH EX		

# CURB/RAMP LAYOUT POINTS						
NUMBER	STATION	OFFSET	ELEV	DESCRIPTION		
400	14+71.87	24.64' RT	316.30	S/W, MATCH EX		
401	14+71.88	19.60' RT	316.29	S/W, MATCH EX		
402	14+76.88	24.67' RT	316.41	S/W		
403	14+76.88	19.67' RT	316.37	S/W		
404	14+76.88	15.74' RT	315.97	FL, MATCH EX		
405	14+81.87	24.66' RT	316.52	RAMP		
406	14+81.88	19.66' RT	316.44	RAMP		
407	14+88.37	24.65' RT	316.58	RAMP		
408	14+88.38	19.61' RT	316.50	RAMP		
409	14+88.38	16.23' RT	316.25	RAMP		

# CURB/RAMP LAYOUT POINTS					
NUMBER	STATION	OFFSET	ELEV	DESCRIPTION	
410	14+88.38	15.73' RT	316.25	RAMP. FL	
411	14+93.37	24.64' RT	316.66	RAMP	
412	14+93.38	19.64' RT	316.58	RAMP	
413	14+93.38	16.23' RT	316.40	RAMP	
414	14+93.38	15.73' RT	316.40	RAMP. FL, PVI	
415	15+08.38	19.66' RT	317.68	RAMP	
416	15+08.39	24.61' RT	317.76	RAMP	
417	15+13.37	24.60' RT	318.10	S/W	
418	15+13.38	19.60' RT	317.99	S/W	

- 1. PLANTER/BACK OF WALK RESTORATION SHALL BE PER RESTORATION TABLE, SHEET 37.
- 2. ALL LOCATION & ELEVATION CALLOUTS ARE TO FINISHED SIDEWALK/RAMP GRADE UNLESS OTHERWISE NOTED.
- 3. VERTICAL INFLECTION POINTS ALONG THE CURB LINE SHALL BE CLEAR OF THE RAMP BOTTOM.
- 4. DETECTABLE WARNING SURFACES LOCATED ON A RADIUS SHALL BE INSTALLED USING DETECTABLE WARNING TILES MANUFACTURED SPECIFICALLY TO BE INSTALLED ON THE SPECIFIED RADIUS.

#### **CONSTRUCTION NOTES**

- 1 INSTALL COMBINATION CURB RAMP PER COT STANDARD PLAN SU-05C.
- (4) INSTALL CEMENT CONC. SIDEWALK PER COT STANDARD PLAN SU-04.
- INSTALL CEMENT CONC. CURB & GUTTER PER COT STANDARD PLAN SU-03. MODIFY DIMENSIONS AS NECESSARY TO MATCH EXISTING CURB & GUTTER.
- (6) CEMENT CONC. PEDESTRIAN CURB PER COT STD PLAN SU-03A.
- 9 TRANSITION PANEL TO MATCH EXISTING SIDEWALK WIDTH AND SLOPE.
  MAY NOT COMPLY WITH ADA STANDARDS.

#### **LEGEND**

	CEMENT CONCRETE SIDEWALK
. 1	CEMENT CONCRETE CURB RAMP & DRIVEWAY
* * * * * * * * * * * * * * * * * * *	PLANTER STRIP / LAWN
	DETECTABLE WARNING SURFACE, PLACE AT GRADE BREAK AND INSTALL PER COT STANDARD PLAN SU-05G
	CEMENT CONCRETE CURB AND GUTTER
<u> </u>	HMA WEDGE CURB

#### ABBREVIATIONS:

FL FLOWLINE
S/W SIDEWALK
TBC TOP OF CURB

CALL 2 DAYS BEFORE YOU DIG 1-800-424-5555 BID DOCUMENT



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					FINAL CONSTRUCTION CHECKED	DATE 05/24	SCALE <b>1"=5'</b>
N. C.					BY	DESIGNED EH	CHECKED NIM
					DATE	drawn <b>EH</b>	PROJECT WWSS-M
ma	NO	R E V I S I O N	DATE	APPD	FIELD BOOKS	DRAWING NAME  McKinley Road & E	J St (North




CITY	OF TACOMA	
ENVIRONMENTAL	SERVICES	DEPARTMENT


MCKINLEY ROAD & EAST J STREET (SOUTH)


ENV-04018-08 PWK-00438-46

ES24-0034F

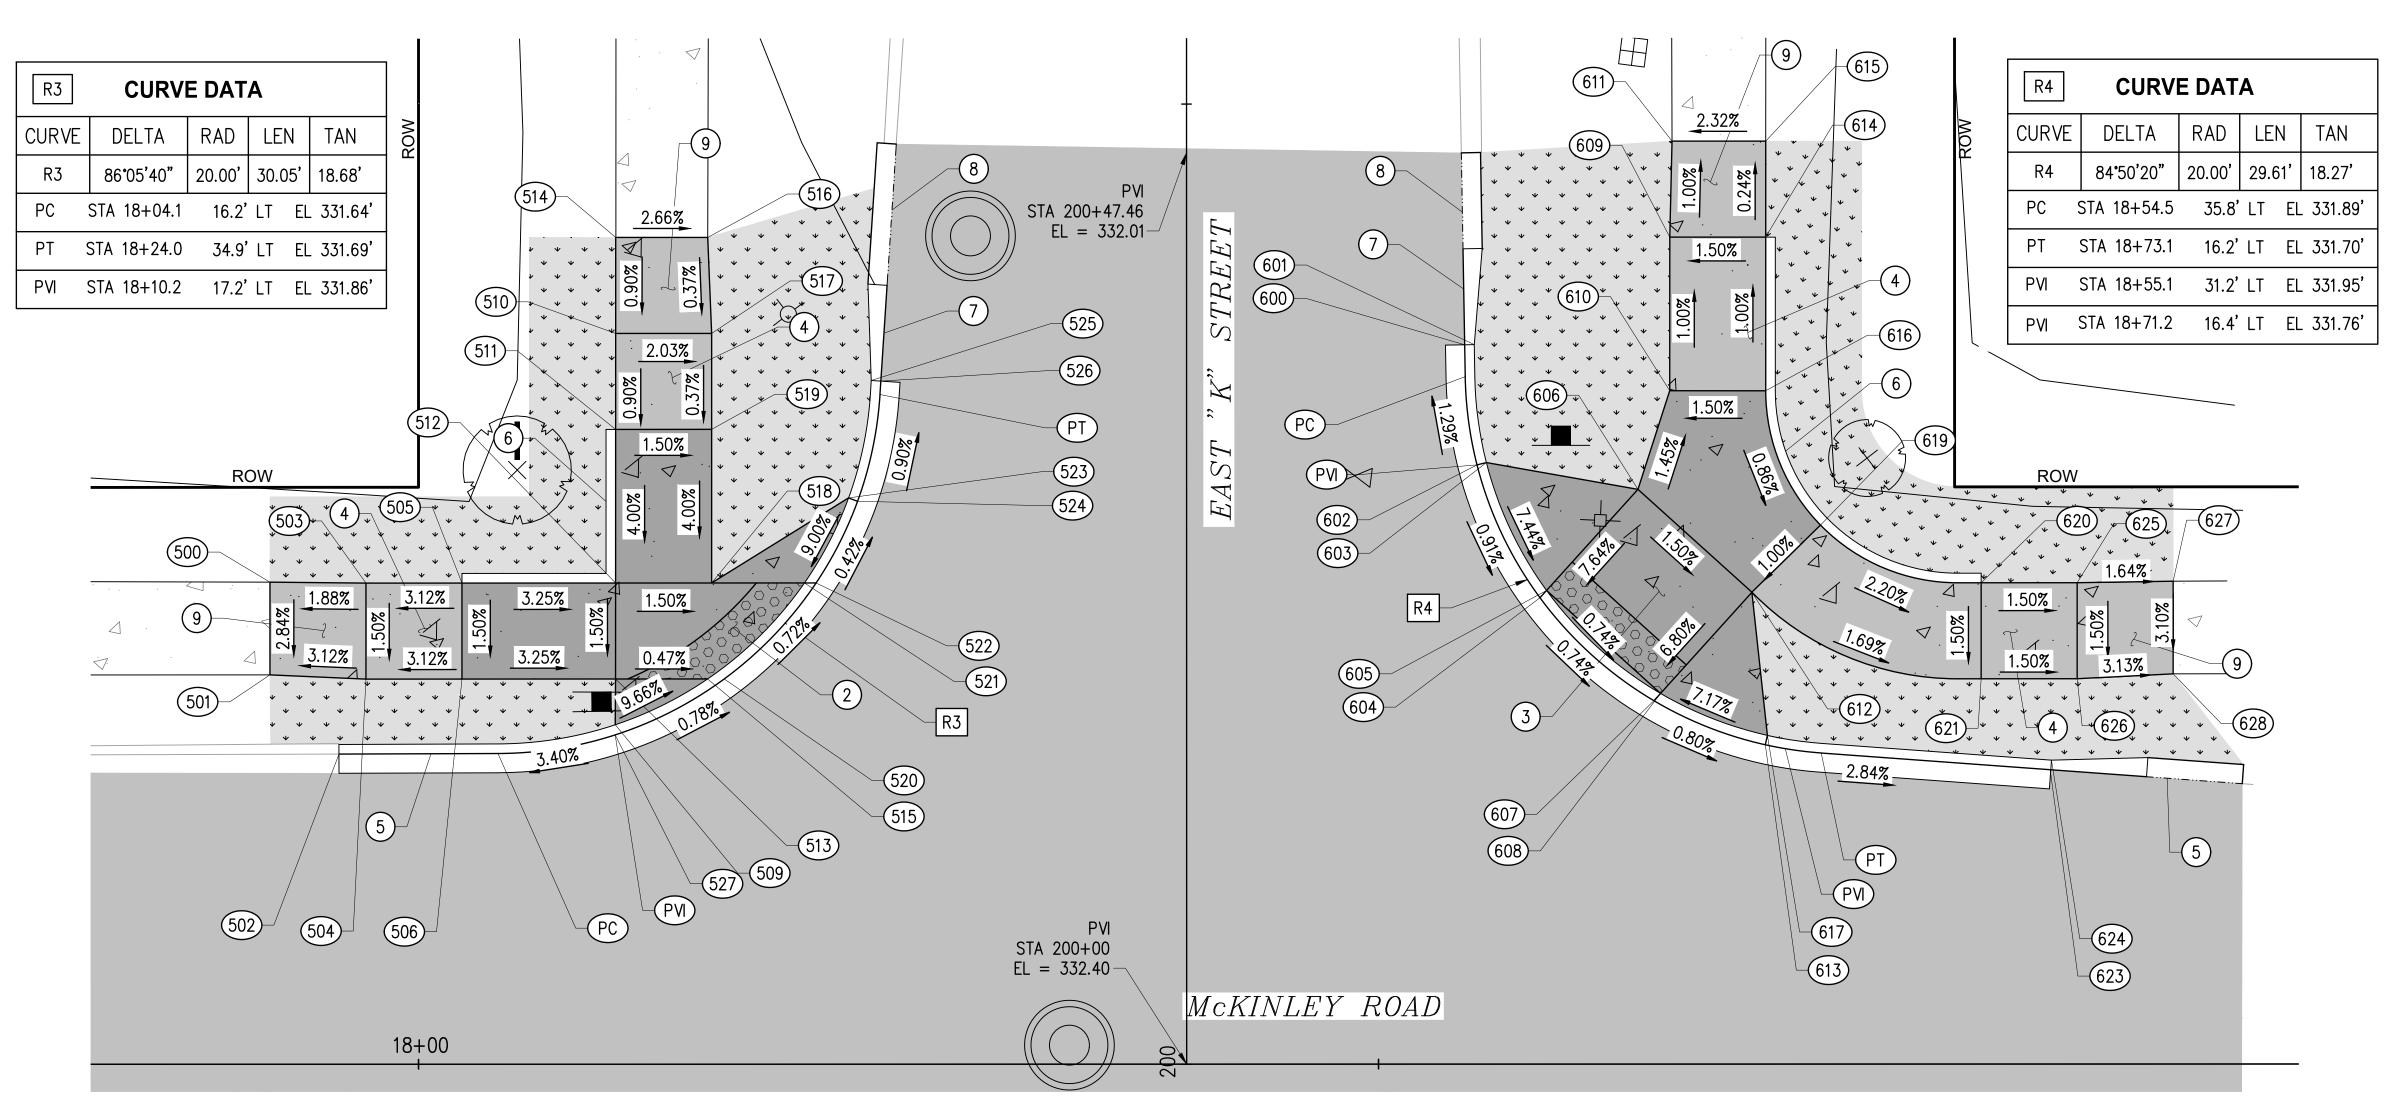

# CURB/RAMP LAYOUT POINTS						
NUMBER	STATION	OFFSET	ELEV	DESCRIPTION		
500	17+92.27	25.11' LT	331.93	S/W, MATCH EX		
501	17+92.27	20.28' LT	331.79	S/W, MATCH EX		
502	17+95.86	16.15' LT	331.34	FL, MATCH EX		
503	17+97.27	25.06' LT	332.02	S/W		
504	17+97.27	20.06' LT	331.95	S/W		
505	18+02.27	25.06' LT	332.18	RAMP		
506	18+02.27	20.06' LT	332.10	RAMP		
509	18+10.25	17.68' LT	332.34	RAMP,TBC		
510	18+10.27	38.06' LT	332.28	S/W		
511	18+10.27	33.06' LT	332.24	RAMP		
512	18+10.27	25.06' LT	331.92	RAMP		
513	18+10.27	20.06' LT	331.84	RAMP		
514	18+10.27	43.06' LT	332.33	S/W, MATCH EX		

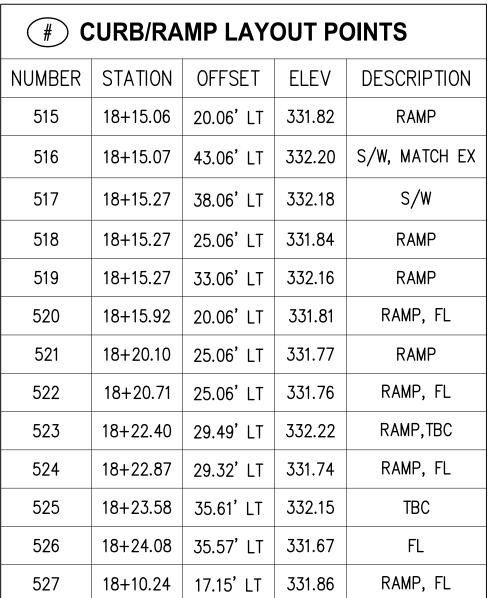

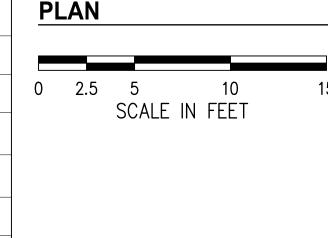

# CURB/RAMP LAYOUT POINTS				
NUMBER	STATION	OFFSET	ELEV	DESCRIPTION
600	18+54.49	37.46' LT	331.87	FL
601	18+54.99	37.47' LT	332.35	TBC
602	18+55.13	31.21' LT	331.95	RAMP, FL
603	18+55.62	31.33' LT	332.43	RAMP, TBC
604	18+58.41	24.29' LT	331.88	RAMP, FL
605	18+58.75	24.67' LT	331.88	RAMP
606	18+63.51	29.93' LT	332.42	RAMP
607	18+64.35	18.92' LT	331.82	RAMP, FL
608	18+64.69	19.30' LT	331.82	RAMP
609	18+65.17	43.07' LT	332.26	S/W
610	18+65.17	35.07' LT	332.34	RAMP
611	18+65.29	48.07' LT	332.21	S/W, MATCH EX
612	18+69.45	24.57' LT	332.30	RAMP
613	18+70.14	16.63' LT	331.77	RAMP, FL

# 0	URB/RA	MP LAY	OUT PO	DINTS
NUMBER	STATION	OFFSET	ELEV	DESCRIPTION
614	18+70.17	43.07' LT	332.34	S/W
615	18+70.17	48.07' LT	332.33	S/W, MATCH EX
616	18+70.17	35.07' LT	332.42	RAMP
617	18+70.25	17.12' LT	333.50	RAMP, TBC
619	18+73.02	28.07' LT	332.35	RAMP
620	18+81.39	25.06' LT	332.16	S/W
621	18+81.39	20.06' LT	332.08	S/W
623	18+84.98	15.33' LT	331.36	FL
624	18+85.05	15.83' LT	331.86	TBC
625	18+86.39	25.07' LT	332.08	S/W
626	18+86.39	20.07' LT	332.01	S/W
627	18+91.39	25.15' LT	332.00	S/W, MATCH EX
628	18+91.39	20.32' LT	331.85	S/W, MATCH EX

- 1. PLANTER/BACK OF WALK RESTORATION SHALL BE PER RESTORATION TABLE, SHEET 37.
- 2. ALL LOCATION & ELEVATION CALLOUTS ARE TO FINISHED SIDEWALK/RAMP GRADE UNLESS OTHERWISE NOTED.
- 3. VERTICAL INFLECTION POINTS ALONG THE CURB LINE SHALL BE CLEAR OF THE RAMP BOTTOM.
- 4. DETECTABLE WARNING SURFACES LOCATED ON A RADIUS SHALL BE INSTALLED USING DETECTABLE WARNING TILES MANUFACTURED SPECIFICALLY TO BE INSTALLED ON THE SPECIFIED RADIUS.

#### **CONSTRUCTION NOTES**

- 2 INSTALL SINGLE DIRECTION TYPE B CURB RAMP PER COT STANDARD PLAN SU-05F.
- 3 INSTALL PERPENDICULAR CURB RAMP TYPE "A" PER COT STANDARD PLAN SU-05A.
- (4) INSTALL CEMENT CONC. SIDEWALK PER COT STANDARD PLAN SU-04.
- 5 INSTALL CEMENT CONC. CURB & GUTTER PER COT STANDARD PLAN SU-03. MODIFY DIMENSIONS AS NECESSARY TO MATCH EXISTING CURB & GUTTER.
- (6) CEMENT CONC. PEDESTRIAN CURB PER COT STD PLAN SU-03A.
- 7 INSTALL HMA WEDGE CURB TRANSITION PER DETAIL 1, SHEET 37. MODIFY DIMENSIONS AS NECESSARY TO MATCH EXISTING HMA WEDGE CURB WIDTH.
- INSTALL HMA WEDGE CURB PER COT STANDARD PLAN SU-03A. 8 MODIFY DIMENSIONS AS NECESSARY TO MATCH EXISTING HMA WEDGE
- 9 TRANSITION PANEL TO MATCH EXISTING SIDEWALK WIDTH AND SLOPE. MAY NOT COMPLY WITH ADA STANDARDS.

#### **LEGEND**

CEMENT CONCRETE SIDEWALK CEMENT CONCRETE CURB RAMP & DRIVEWAY PLANTER STRIP / LAWN DETECTABLE WARNING SURFACE, PLACE AT GRADE BREAK AND INSTALL PER COT STANDARD PLAN SU-05G CEMENT CONCRETE CURB AND GUTTER HMA WEDGE CURB

#### ABBREVIATIONS:

FLOWLINE SIDEWALK TOP OF CURB

CALL 2 DAYS **BEFORE YOU DIG** 1-800-424-5555


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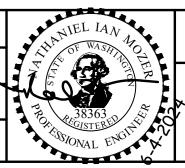
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		FIELD BOOKS	DRAWING NAME  McKinley Road & E	I St (North)
		DATE	DRAWN EH	PROJECT N
		ВҮ	DESIGNED EH	CHECKED NIM
		FINAL CONSTRUCTION CHECKED	DATE <b>05/24</b>	SCALE 1"=5'







WASTEWATER SIDE SEWER IMPROVEMENTS MCKINLEY ROAD CURB RAMP & INTERSECTION GRADING PLAN MCKINLEY ROAD & EAST K ST (NORTH)

ENV-04018-08 PWK-00438-46

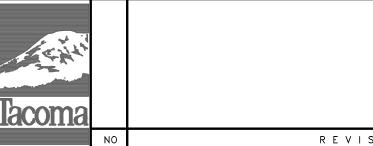ES24-0034F

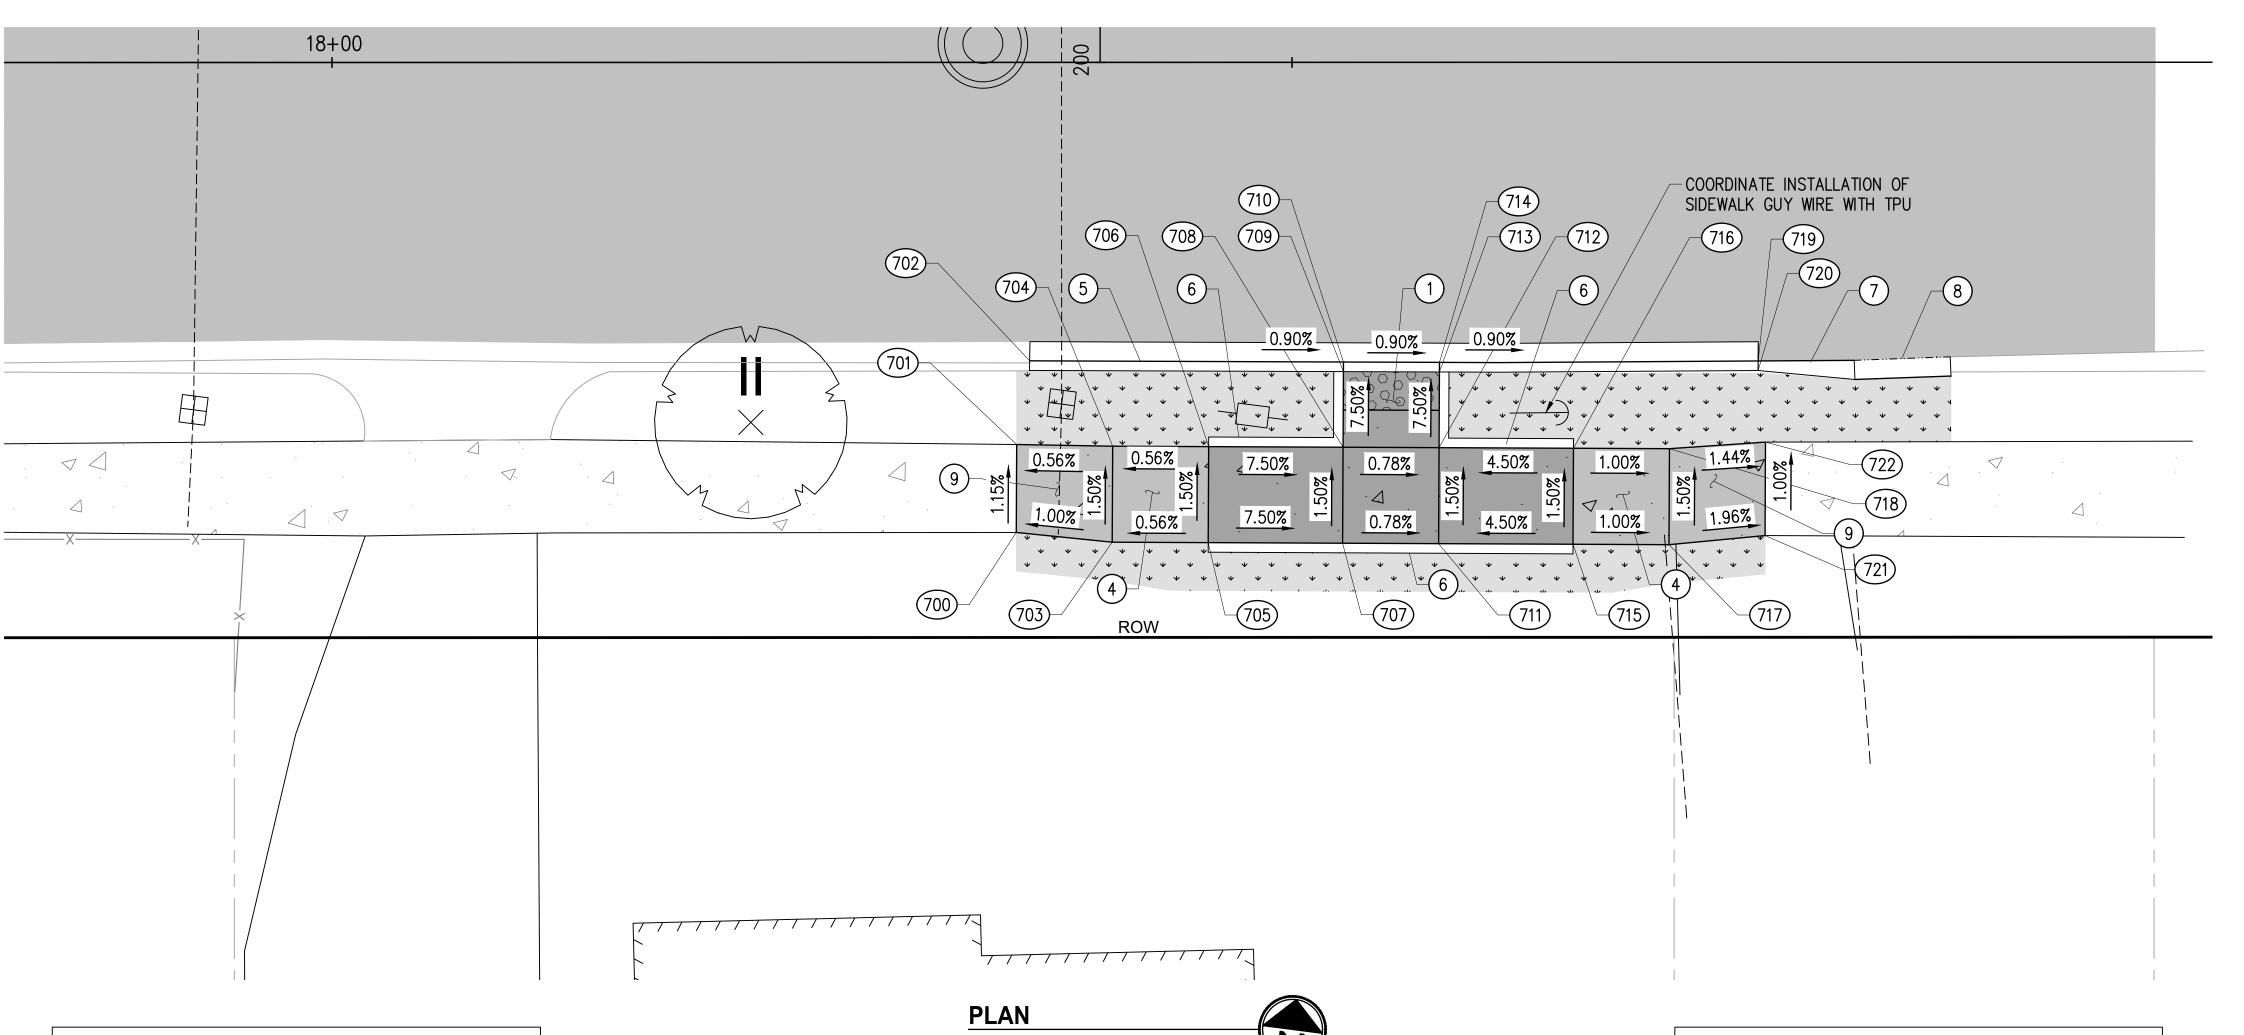

# C	# CURB/RAMP LAYOUT POINTS					
NUMBER	STATION	OFFSET	ELEV	DESCRIPTION		
700	18+35.64	24.48' RT	332.53	S/W, MATCH EX		
701	18+35.66	19.90' RT	332.48	S/W, MATCH EX		
702	18+36.33	15.54' RT	331.86	FL, MATCH EX		
703	18+40.63	24.99' RT	332.58	S/W		
704	18+40.66	19.99' RT	332.50	S/W		
705	18+45.63	25.01' RT	332.61	RAMP		
706	18+45.66	20.01' RT	332.53	RAMP		
707	18+52.63	25.04' RT	332.08	RAMP		
708	18+52.66	20.04' RT	332.01	RAMP		
709	18+52.67	16.10' RT	331.71	RAMP		
710	18+52.68	15.60' RT	331.71	RAMP, FL		
711	18+57.63	25.06' RT	332.04	RAMP		

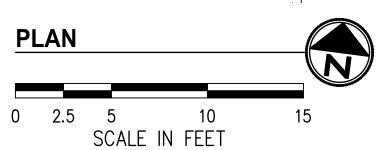

# (	# CURB/RAMP LAYOUT POINTS						
NUMBER	STATION	OFFSET	ELEV	DESCRIPTION			
712	18+57.66	20.06' RT	331.97	RAMP			
713	18+57.67	16.12' RT	331.67	RAMP			
714	18+57.68	15.62' RT	331.67	RAMP, FL			
715	18+64.63	25.10' RT	332.36	RAMP			
716	18+64.66	20.10' RT	332.28	RAMP			
717	18+69.63	25.12' RT	332.31	S/W			
718	18+69.66	20.12' RT	332.23	S/W			
719	18+74.28	15.55' RT	331.52	FL			
720	18+74.28	16.05' RT	332.00	TBC			
721	18+74.63	24.64' RT	332.21	S/W, MATCH EX			
722	18+74.66	19.78' RT	332.16	S/W, MATCH EX			

- 1. PLANTER/BACK OF WALK RESTORATION SHALL BE PER RESTORATION TABLE, SHEET 37.
- 2. ALL LOCATION & ELEVATION CALLOUTS ARE TO FINISHED SIDEWALK/RAMP GRADE UNLESS OTHERWISE NOTED.
- 3. VERTICAL INFLECTION POINTS ALONG THE CURB LINE SHALL BE CLEAR OF THE RAMP BOTTOM.
- 4. DETECTABLE WARNING SURFACES LOCATED ON A RADIUS SHALL BE INSTALLED USING DETECTABLE WARNING TILES MANUFACTURED SPECIFICALLY TO BE INSTALLED ON THE SPECIFIED RADIUS.

#### **CONSTRUCTION NOTES**

- 1 INSTALL COMBINATION CURB RAMP PER COT STANDARD PLAN SU-05C.
- (4) INSTALL CEMENT CONC. SIDEWALK PER COT STANDARD PLAN SU-04.
- INSTALL CEMENT CONC. CURB & GUTTER PER COT STANDARD PLAN SU-03. MODIFY DIMENSIONS AS NECESSARY TO MATCH EXISTING CURB & GUTTER.
- (6) CEMENT CONC. PEDESTRIAN CURB PER COT STD PLAN SU-03A.
- 7 INSTALL HMA WEDGE CURB TRANSITION PER DETAIL 1, SHEET 37.
  MODIFY DIMENSIONS AS NECESSARY TO MATCH EXISTING HMA WEDGE CURB WIDTH.
- INSTALL HMA WEDGE CURB PER COT STANDARD PLAN SU-03A.

  MODIFY DIMENSIONS AS NECESSARY TO MATCH EXISTING HMA WEDGE CURB WIDTH.
- 9 TRANSITION PANEL TO MATCH EXISTING SIDEWALK WIDTH AND SLOPE. MAY NOT COMPLY WITH ADA STANDARDS.

#### **LEGEND**

CEMENT CONCRETE SIDEWALK

CEMENT CONCRETE CURB RAMP & DRIVEWAY

planter strip / lawn

DETECTABLE WARNING SURFACE, PLACE AT GRADE
BREAK AND INSTALL PER COT STANDARD PLAN SU-05G

CEMENT CONCRETE CURB AND GUTTER

HMA WEDGE CURB

#### ABBREVIATIONS:

FL FLOWLINE
S/W SIDEWALK
TBC TOP OF CURB

CALL 2 DAYS BEFORE YOU DIG 1-800-424-5555


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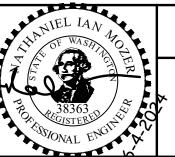


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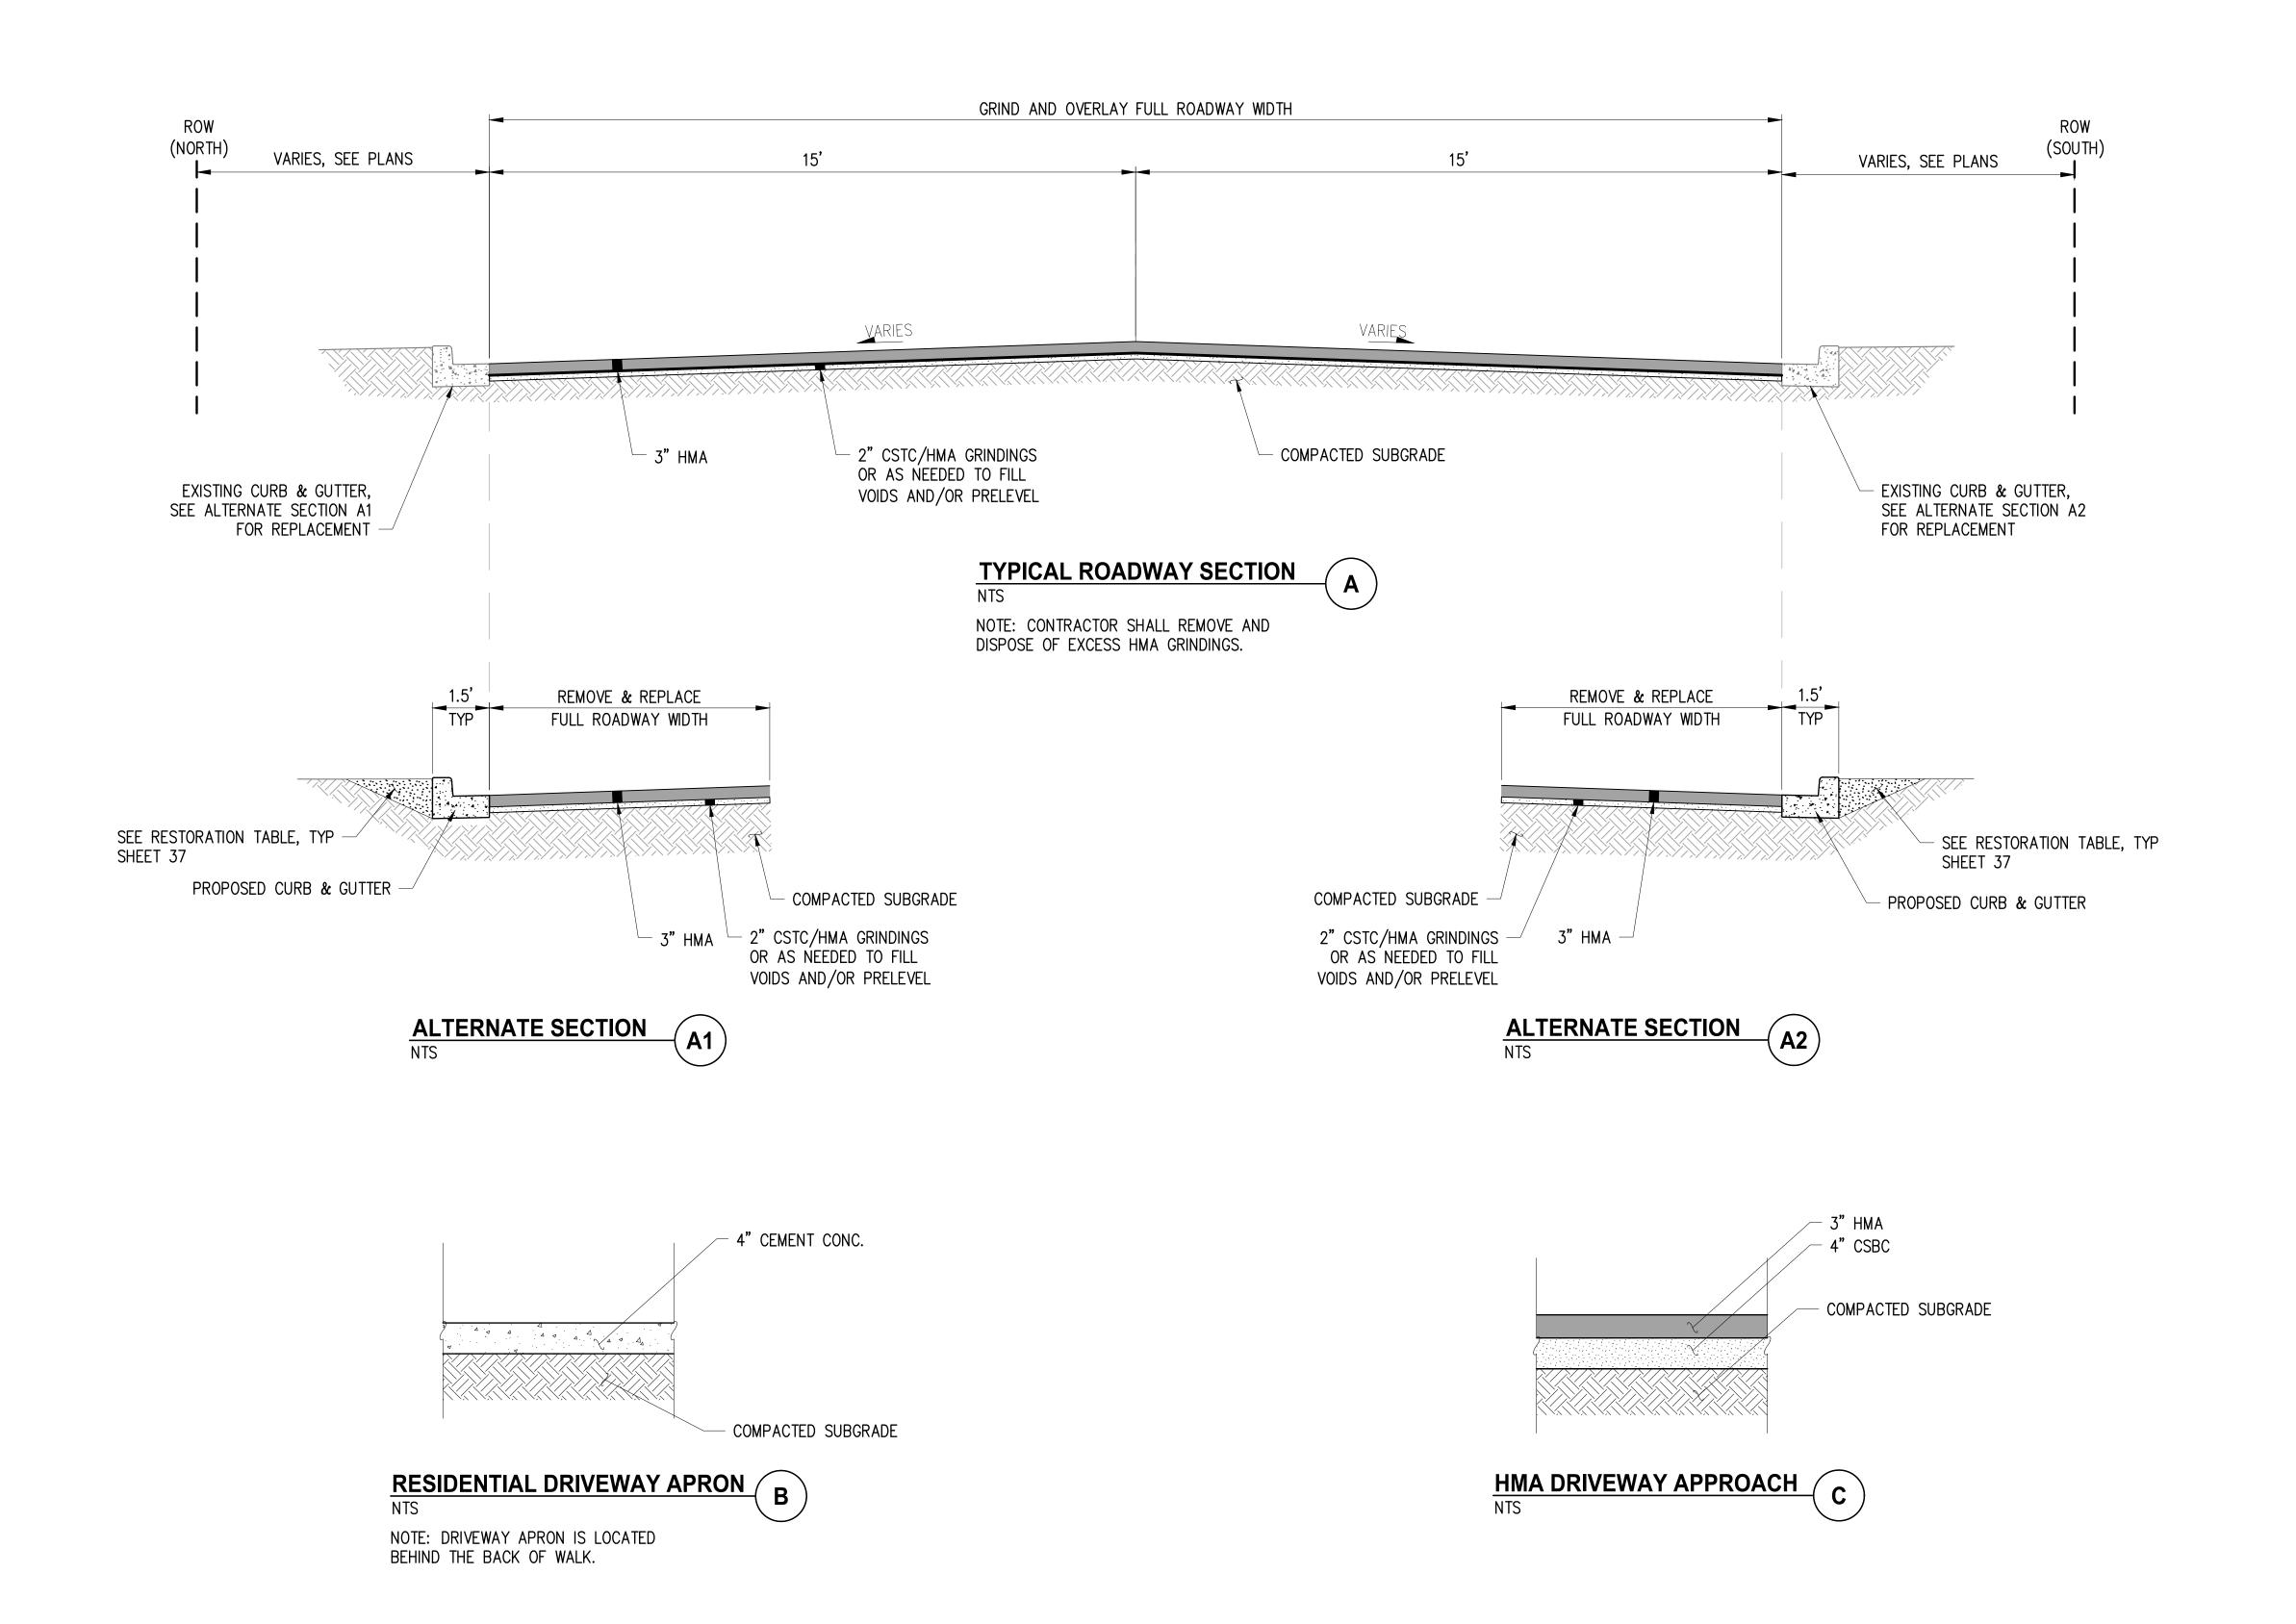
CITY OF TACOMA
ENVIRONMENTAL SERVICES DEPARTMENT

WASTEWATER SIDE SEWER IMPROVEMENTS MCKINLEY ROAD CURB RAMP & INTERSECTION GRADING PLAN

MCKINLEY ROAD & EAST K ST (SOUTH)

ENV-04018-08 PWK-00438-46

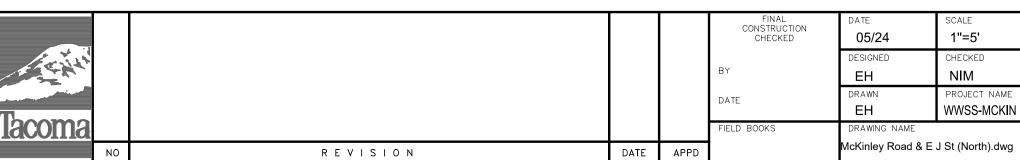ES24-0034F



**CALL 2 DAYS BEFORE YOU DIG** 1-800-424-5555

BID **DOCUMENT** 

**KPG** P S O M A S 2502 Jefferson Avenue Tacoma, WA 98402 253.627.0720

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CITY OF TACOMA Horizontal Datum N.A.D. '83/91 Vertical Datum N.G.V.D. '29

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	NO	REVISION	DATE	APPD

FINAL CONSTRUCTION CHECKED 05/24 NTS WWSS-MCKIN Typical Sections.dwg

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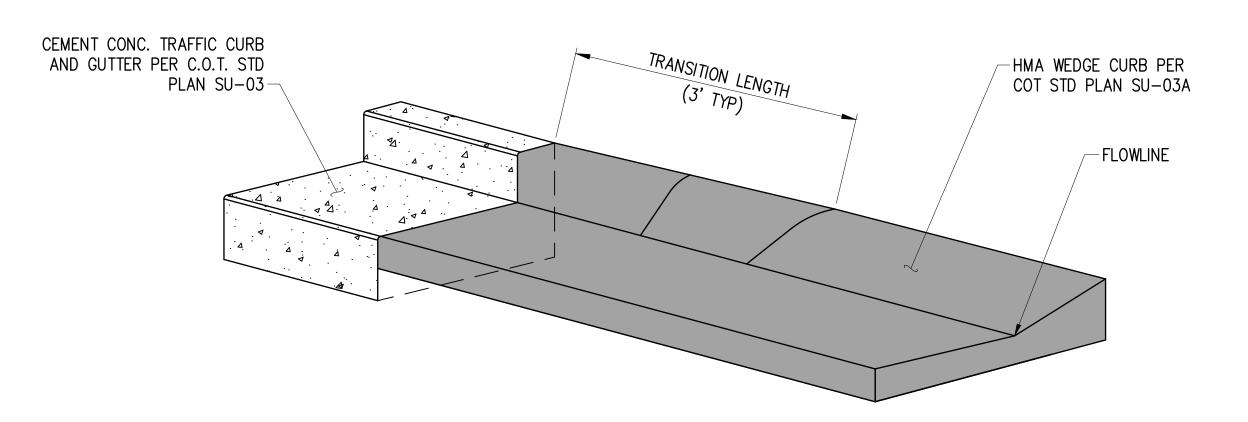
CITY OF TACOMA
ENVIRONMENTAL SERVICES DEPARTMENT WASTEWATER SIDE SEWER IMPROVEMENTS MCKINLEY ROAD

ENV-04018-08 PWK-00438-46


ES24-0034F

36 <sub>OF</sub> 37

TYPICAL SECTIONS




TRANSITION TRAFFIC CURB AND **GUTTER TO HMA WEDGE CURB DETAIL** SEE PLANS FOR LOCATION NTS

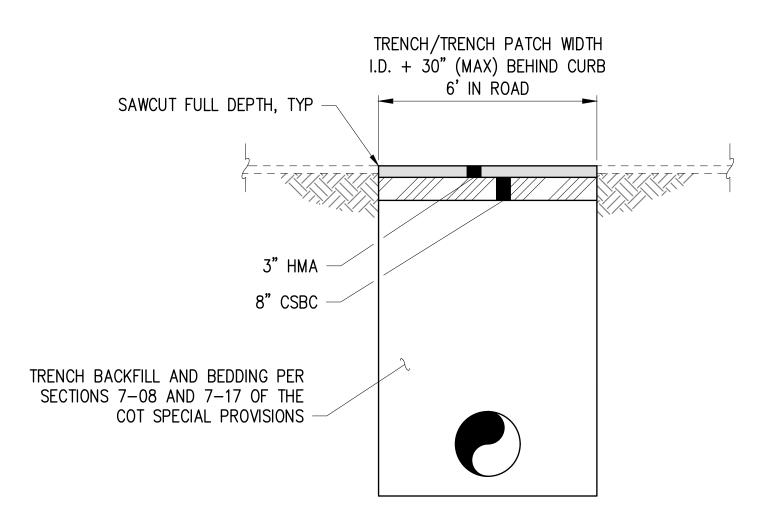

TEMPORARY TRENCH PATCH (ROW ONLY) DETAIL

	RESTORATION TABLE						
RESTORATION TYPE	RESTORATION	COMMENTS					
НМА	2" MINIMUM HMA OVER 2" CSTC AT BACK OF SIDEWALK OR DRIVEWAY	FINISHED GRADE SHALL BE SMOOTH AND CONSISTENT WITH EXISTING GRADE.					
LAWN/PLANTER STRIP	SOD OVER TYPE A TOPSOIL	FINISHED GRADE SHALL BE SMOOTH AND CONSISTENT WITH EXISTING GRADE.					
PRIVATE LANDSCAPE AREAS/UNIMPROVED AREAS	3" BARK MULCH OVER 4" TOPSOIL TYPE A	FINISHED GRADE SHALL BE SMOOTH AND CONSISTENT WITH EXISTING GRADE.					
GRAVEL	CSTC PLACED AT 3" TYPICAL DEPTH	PLACE CSTC FROM BACK OF CURB, BACK OF WALK, EDGE OF SHOULDER, OR EDGE OF PAVEMENT TO EXISTING GRADE FOR 3'. GRADE NOT TO EXCEED 4H:1V					

LOCATIONS OF RESTORATION ARE TYPICAL AND MAY BE REVISED BASED ON PROPERTY OWNER'S PREFERENCE AND APPROVAL BY CITY. FINAL RESTORATION TYPE SHALL BE DETERMINED BY THE CITY.

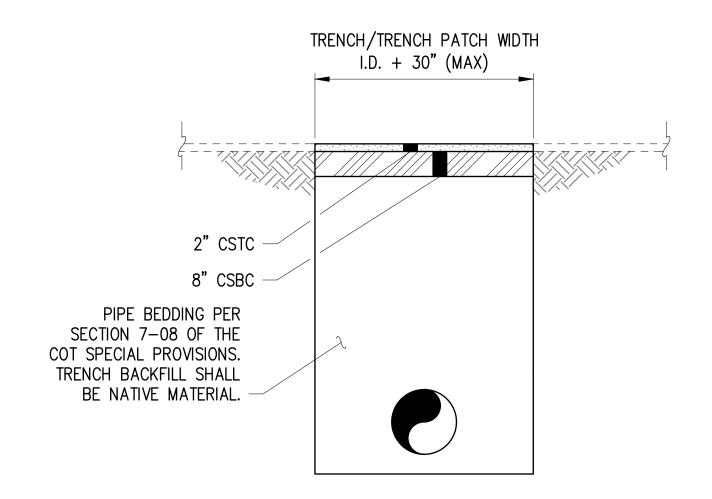

PRIVATE PROPERTY TEMPORARY PATCH DETAIL

NTS

**CALL 2 DAYS BEFORE YOU DIG** 1-800-424-5555

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	NO	REVISION

		FINAL CONSTRUCTION CHECKED	DATE 05/24	SCALE NTS	
			DESIGNED	CHECKED	<u>و</u> ا
		BY	EH	NIM	₹
		DATE	DRAWN	PROJECT NAME	17
			EH	WWSS-MCKIN	3
		FIELD BOOKS	DRAWING NAME		
DATE	APPD		Typical Details.dwg		



# CITY OF TACOMA ENVIRONMENTAL SERVICES DEPARTMENT WASTEWATER SIDE SEWER IMPROVEMENTS MCKINLEY ROAD TYPICAL DETAILS

ENV-04018-08 PWK-00438-46

ES24-0034F